

SCHEMATIC DESIGN PLANS & DETAILS NOT FOR CONSTRUCTION

CALIFORNIA DEPARTMENT OF GENERAL SERVICES



SHEET NO.



PROJECT E.I.P. # 560

South Lake Taboe, CA 96150 Tel: 530.543.5100 Fax: 530.543.5150



Zephyr Cove, NV 89448 Tel: 775.588.9069

TITLE SHEET

REVISIONS

description


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CALIFORNIA TAHOE CONSERVANCY

UPPER TRUCKEE RIVER AND MARSH RESTORATION PROJECT





LOCATION MAP SOUTH LAKE TAHOE, EL DORADO COUNTY, CA

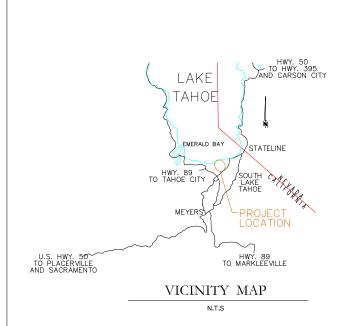

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TITLE

GENERAL NOTES

- ALL IMPROVEMENTS SHALL BE ACCOMPLISHED LINDER THE APPROVAL INSPECTION, AND TO THE SATISFACTION OF THE CALIFORNIA DEPARTMENT OF GENERAL SERVICES (DGS), IMPROVEMENT CONSTRUCTION SHALL COMPLY WITH THESE PLANS AND THE 2010 CALTRANS STANDARD PLANS FOR CONSTRUCTION OF LOCAL STREETS AND ROADS, UNLESS NOTED OTHERWISE. ALL REFERENCES TO THE "STANDARD SPECIFICATIONS" SHALL MEAN THE STATE OF CALIFORNIA, DEPARTMENT OF TRANSPORTATION (CALTRANS) STANDARD SPECIFICATIONS FOR CONSTRUCTION OF LOCAL STREETS AND ROADS, 2010, INCLUDING THE AMENDMENTS TO THE 2010 STANDARD SPECIFICATIONS. CONSTRUCTION NOT SPECIFIED ON THESE PLANS OR IN SPECIFIC CITY OF SOUTH LAKE TAHOF (CSLT) ORDINANCES SHALL CONFORM TO THE REQUIREMENTS OF THE STANDARD SPECIFICATIONS. THE CONTRACTOR IS OBLIGATED TO BE FAMILIAR WITH APPLICABLE SECTIONS OF THE STANDARD SPECIFICATIONS NOT DISCUSSED IN THE GENERAL NOTES. THE CONTRACT SPECIAL PROVISIONS SHALL SUPERSEDE THOSE OF THE STANDARD SPECIFICATIONS WHERE DISCREPANCIES OCCUR.
- 2. CONSTRUCTION HOURS SHALL BE WEEKDAYS BETWEEN 8:00 A.M. AND 6:30 P.M. UNLESS PRIOR APPROVAL IS
- 3. THE LOCATIONS AND EXTENT OF EXISTING UNDERGROUND UTILITIES IN THE WORK AREA AS SHOWN ARE APPROXIMATE AND ARE NOT NECESSARILY COMPLETE. A REASONABLE EFFORT HAS BEEN MADE TO LOCATE AND DELINEATE EXISTING UTILITIES BASED UPON AVAILABLE RECORDS. THE CONTRACTOR SHALL DETERMINE THE TYPE, LOCATION, SIZE, AND/OR DEPTH OF THE EXISTING UTILITIES WITHIN THE WORK AREA BEFORE COMMENCING WORK THE CONTRACTOR OR ANY SUBCONTRACTOR FOR THIS CONTRACT SHALL BE FULLY RESPONSIBLE FOR ANY AND ALL DAMAGES WHICH MIGHT BE OCCASIONED BY THE FAILURE TO EXACTLY LOCATE AND PRESERVE ANY AND ALL UNDERGROUND UTILITIES. THE CONTRACTOR SHALL CONTACT UNDERGROUND SERVICE ALERT AT (800) 227-2600 AT LEAST 48 HOURS PRIOR TO ANY CONSTRUCTION. SEE SPECIAL PROVISIONS FOR CONTRACTOR NOTIFICATION REQUIREMENTS. THE CONTRACTOR SHALL ASSUME COMPLETE RESPONSIBILITY FOR DAMAGED UTILITIES.
- 4. UNLESS NOTED OTHERWISE ON THE PLANS. THE CONTRACTOR SHALL BE RESPONSIBLE FOR THE PROTECTION OF ALL EXISTING SURVEY MONUMENTS AND OTHER SURVEY MARKERS DURING CONSTRUCTION
- THE CONTRACTOR SHALL PROVIDE, PLACE, AND MAINTAIN ALL LIGHTS, SIGNS, BARRICADES, FLAG PERSONS PILOT CAR, OR OTHER DEVICES NECESSARY TO CONTROL TRAFFIC THROUGH THE CONSTRUCTION AREA AND FOR PUBLIC SAFETY IN ACCORDANCE WITH THESE PLANS. THE STANDARD SPECIFICATIONS, FEDERAL HIGHWAY ADMINISTRATION (FHWA) MANUAL ON UNIFORM TRAFFIC CONTROL DEVICES (MUTCD) 2009 EDITION AND MUTCD 2012 CALIFORNIA SUPPLÉMENT.
- 6. THE CONTRACTOR AGREES TO ASSUME SOLE AND COMPLETE RESPONSIBILITY FOR JOB SITE CONDITIONS DURING THE COURSE OF CONSTRUCTION OF THIS PROJECT, INCLUDING SAFETY OF ALL PERSONS AND PROPERTY, AND FURTHER AGREES THAT THIS REQUIREMENT SHALL APPLY CONTINUOUSLY AND NOT BE LIMITED TO NORMAL WORKING HOURS IN ACCORDANCE WITH THE PROVISIONS OUTLINED BY THE PROJECT CONTRACT AND STANDARD SPECIFICATIONS.
- THERE SHALL BE NO GRADING OR LAND DISTURBANCE PERFORMED WITH RESPECT TO THE PROJECT BETWEEN OCTOBER 15 AND MAY 1 UNLESS A GRADING EXEMPTION IS OBTAINED FROM THE TAHOE REGIONAL PLANNING AGENCY (TRPA), APPROVALS FOR GRADING BETWEEN OCTOBER 15 AND MAY 1 MUST ALSO BE OBTAINED FROM THE REGIONAL WATER QUALITY CONTROL BOARD, LAHONTAN. IF REQUIRED, THE COUNTY SHALL OBTAIN THESE APPROVALS.
- 8. THE CONTRACTOR SHALL MAINTAIN A SET OF PLANS ON THE JOB SHOWING "AS-CONSTRUCTED" CHANGES MADE TO DATE. UPON COMPLETION OF THE PROJECT, THE CONTRACTOR SHALL SUPPLY TO THE AGENCIES A SET OF PLANS, MARKED UP TO THE SATISFACTION OF THE AGENCIES, REFLECTING THE AS-CONSTRUCTED
- 9. ALL CONTROL STATIONING AND DATA DIMENSIONING ARE REFERENCED TO THE CENTERLINE OF THE FACILITY SHOWN UNLESS OTHERWISE NOTED
- 10. AT NO TIME SHALL THE CONTRACTOR UNDERTAKE TO CLOSE OFF ANY EXISTING UTILITY LINES OR OPEN VALVES OR TAKE ANY OTHER ACTION WHICH WOULD AFFECT THE OPERATION OF EXISTING WATER OR SEWER SYSTEMS WITHOUT PRIOR APPROVAL FROM THE SOUTH TAHOE PUBLIC UTILITY DISTRICT (STPUD), APPROVAL SHALL BE REQUESTED AT LEAST 48 HOURS IN ADVANCE OF THE TIME THAT THE INTERRUPTION OF THE EXISTING SYSTEM IS REQUIRED. ANY INTERRUPTION OF SERVICE TO ACTIVE WATER OR SEWER SERVICES, INCLUDING FIRE HYDRANTS, WHETHER INTENTIONAL OR NOT, MUST BE KEPT TO A MINIMUM TIME PERIOD. IF SERVICE TO BUILDINGS IS TO BE OFF FOR MORE THAN FOUR HOURS, THE CONTRACTOR MUST ADVISE STPUD.
- 11. THE CONTRACTOR SHALL BE REQUIRED TO PERFORM PREVENTIVE DUST CONTROL MEASURES TO ENSURE THAT DUST RESULTING FROM THE CONTRACTOR'S PERFORMANCE OF THE WORK IS CONTROLLED IN CONFORMANCE WITH THE SPECIAL PROVISIONS, THE PROVISIONS THE STANDARD SPECIFICATIONS, COUNTY, AND LOCAL ORDINANCES. SEE SPECIAL PROVISIONS REGARDING SWEEPING, DUST CONTROL AND TRACKING REQUIREMENTS
- 12. THE CONTRACTOR SHALL BE RESPONSIBLE FOR IMPLEMENTING ALL TEMPORARY EROSION CONTROL MEASURES. THE EROSION CONTROL MEASURES SHALL BE IN ACCORDANCE WITH THE TRPA "HANDBOOK OF BEST MANAGEMENT PRACTICES" AND THE STORM WATER POLLUTION PREVENTION PLAN (SWPPP). THE DOT SHALL CONTACT TRPA PRIOR TO THE COMMENCEMENT OF WORK FOR A PRE-GRADING INSPECTION OF THE INSTALLED TEMPORARY EROSION CONTROL FACILITIES. THE CONTRACTOR SHALL BE RESPONSIBLE FOR THE MAINTENANCE AND PERFORMANCE OF THE TEMPORARY EROSION CONTROL MEASURES THROUGHOUT THE DURATION OF THE PROJECT. SEE SPECIAL PROVISIONS REGARDING TEMPORARY EROSION CONTROL FACILITY
- 13. CONSTRUCTION LIMITS SHOWN ON THE PLANS DELINEATE BOUNDARIES FOR THE CONTRACTOR'S OPERATIONS OUTSIDE THE COUNTY STREET RIGHT-OF-WAY. CONSTRUCTION LIMIT FENCING SHALL BE ERECTED ALONG THESE BOUNDARIES PRIOR TO COMMENCEMENT OF CONSTRUCTION. WITHIN THE CONSTRUCTION LIMITS, EXISTING VEGETATION SHALL BE PROTECTED TO THE EXTENT FEASIBLE, ALL EXISTING TREES SHALL BE PROTECTED UNLESS SHOWN ON THE PLANS TO BE REMOVED. SEE SPECIAL PROVISIONS REGARDING PAYMENT FOR TREE REMOVAL
- 14. ALL REVEGETATION SHOWN ON THE PLANS IS TO BE COMPLETED BY OTHERS, UNLESS NOTED OTHERWISE.
- 15. THE CONTRACTOR SHALL USE ONLY DESIGNATED SPECIFIC SITES FOR STORAGE OF EQUIPMENT AND MATERIALS AS SHOWN ON THESE PLANS. THE CONTRACTOR SHALL BE RESPONSIBLE FOR THE SECURITY OF ALL
- 16. IT IS THE RESPONSIBILITY OF THE CONTRACTOR AND HIS SUBCONTRACTOR(S) TO EXAMINE THE PROJECT SITE PRIOR TO THE OPENING OF BID PROPOSALS, THE CONTRACTOR SHALL BECOME FAMILIAR WITH THE CONDITIONS UNDER WHICH THE WORK IS TO BE PERFORMED, SUCH AS THE NATURE AND LOCATION OF THE WORK AND THE GENERAL AND LOCAL CONDITIONS, PARTICULARLY THOSE AFFECTING THE AVAILABILITY OF TRANSPORTATION, THE DISPOSAL, HANDLING, AND STORAGE OF MATERIALS, AVAILABILITY OF LABOR, WATER ELECTRICITY, ROADS, THE UNCERTAINTIES OF WEATHER, THE CONDITIONS OF THE GROUND, SURFACE AND SUBSURFACE MATERIALS, THE EQUIPMENT AND FACILITIES NEEDED PRIMARILY FOR AND DURING THE PERFORMANCE OF THE WORK, AND THE COSTS THEREOF. ANY FAILURE BY THE CONTRACTOR AND SUBCONTRACTOR(S) TO ACQUAINT HIMSELF WITH ALL THE AVAILABLE INFORMATION WILL NOT RELIEVE HIM FROM RESPONSIBILITY FOR PROPERLY ESTIMATING THE DIFFICULTY AND COST OF SUCCESSFULLY

- 17 FLEVATIONS SHOWN ON THE PLANS FOR PIPE INVERTS, TOPS OF GRATES, RIMS, CURBS, ETC. ARE BASED LIPON THE TOPOGRAPHIC INFORMATION SHOWN ON THE PLANS. THE CONTRACTOR SHALL VERIFY ALL NECESSARY SURFACE ELEVATIONS IN THE FIELD AND NOTIFY THE DGS OF ANY DISCREPANCIES, WHICH MIGHT AFFECT PROPER OPERATION OF THE NEW FACILITIES BEFORE BREAKING GROUND AND PRIOR TO FACILITY INSTALLATION. THE DOT SHALL BE CONTACTED IN THE EVENT ELEVATIONS ARE INCORRECT SO THAT THE PROPER ADJUSTMENTS CAN BE MADE PRIOR TO THE INSTALLATION OF THE FACILITIES, AS SET FORTH IN THE
- 18. THE CONTRACTOR SHALL OBTAIN AT HIS OWN EXPENSE ALL PERMITS, LICENSES, INSURANCE POLICIES, ETC., NOT ALREADY OBTAINED BY DGS. AS MAY BE NECESSARY TO COMPLY WITH STATE AND LOCAL LAWS ASSOCIATED WITH THE PERFORMANCE OF THE WORK, SEE SPECIAL PROVISIONS.
- 19. THE CONTRACTOR IS RESPONSIBLE TO REVIEW THE CONTRACT DOCUMENTS FOR ALL SUBMITTALS REQUIRED
- 20. THE DGS WILL FURNISH THE CONSTRUCTION STAKING TO THE CONTRACTOR AS SET FORTH IN THE SPECIAL
- 21. CONTRACTOR SHALL NOTE THAT THE PLANS SHOW BOTH HORIZONTAL AND SLOPE (ACTUAL) LENGTHS FOR PIPE. SEE SPECIAL PROVISIONS FOR THE MAXIMUM ALLOWABLE DEFLECTION ANGLE AT EACH PIPE JOINT
- 22. THE CONSULTANT TEAM AND OVERSEEING ENGINEER RESPONSIBLE FOR PREPARATION OF THESE PLANS AND SPECIFICATIONS WILL NOT BE RESPONSIBLE FOR, OR LIABLE FOR UNAUTHORIZED CHANGES TO OR USES OF THESE PLANS. ALL CHANGES TO THE PLANS MUST BE IN WRITING AND MUST BE APPROVED BY THE CONSULTANT TEAM AND OVERSEEING ENGINEER RESPONSIBLE FOR PREPARATION OF THESE PLANS
- 23. NO TREES OR WETLAND VEGETATION SHALL BE REMOVED UNLESS THEY ARE SHOWN AND NOTED TO BE REMOVED ON THE PLANS, OR AS DIRECTLY SPECIFIED ON-SITE BY THE PROJECT MANAGEMENT STAFF. ALL TREES CONFLICTING WITH GRADING SHALL BE TRIMMED. NO GRADING SHALL TAKE PLACE WITHIN THE DRIP LINE OF TREES NOT TO BE REMOVED UNLESS OTHERWISE APPROVED.
- 24. IF, DURING CONSTRUCTION, ARCHAEOLOGICAL REMAINS ARE ENCOUNTERED, CONSTRUCTION IN THE VICINITY SHALL BE HALTED, AND THE STATE OFFICE OF HISTORIC PRESERVATION AND A QUALIFIED ARCHEOLOGIST SHALL BE NOTIFIED IMMEDIATELY.
- 25. PERMIT CONDITIONS MAY CONTAIN SPECIFIC REQUIREMENTS FOR THE CONTROL OF OFF-SITE TURBIDITY FROM PROJECT OPERATIONS. TURBIDITY WILL BE MONITORED ON A FREQUENT BASIS BY THE PROJECT MANAGEMENT AND INSPECTION STAFF ON-SITE. TURBIDITY AMOUNTS IN EXCESS OF THE PERMITTED AMOUNT AND/OR DURATIONS WILL CAUSE WORK TO BE STOPPED UNTIL IMPROVED PRACTICES ARE IN FEFECT AND THE PROBLEMS CONTROLLED. THE CONTRACTOR IS COMPLETELY RESPONSIBLE FOR ANY PROJECT DELAYS THAT OCCUR BY NATURE OF THIS FAILURE TO ADEQUATELY CONTAIN SEDIMENT ON-SITE
- 26. THE NEW CHANNEL ALIGNEMENTS OF EACH ALTERNATIVE DEPICTED ON THE PLANS ARE APPROXIMATE AND ARE NOT INTENDED TO REPRESENT THE FINAL ALIGNEMENT

ABBREVIATIONS

A ABAND ABAND AC APN BLVD CA CALC'S CF CIR CCIR CONC CONST CMP CT CT CT CT CT CT DGS DIA OR DIA OR DISS DIA DISS DISS	ASPEN ABANDONED ASPHALT CONCRETE ASSESSOR'S PARCEL NUMBER BOULEVARD CALIFORNIA CALCULATIONS CUBIC FEET OR CURB FACE CIRCLE CENTERLINE CONSTRUCTION LIMIT FENCE CLEAR COUNTY CONCRETE CONSTRUCT CORRUGATED METAL PIPE CALTRANS OR COURT CALIFORNIA TAHOE CONSERVANCY CUBIC YARD DETAIL DEPARTMENT OF GENERAL SERVICES DRAINAGE INLET DIAMETER DISSIPATER DRIVE DRIVE DRIVE DRIVE BAST EACH EXISTING GRADE ELEVATION ELECTRIC EDGE OF PAVEMENT EXISTING FIR	FL FS G IE INST IB LF LT BLVD MISC N NTS OH PP PROP PUE RD REF ROW RSP RT S SD SDMH SF SHT SS STA STPUD TRPA	FLOWLINE FINISH SURFACE GAS INVERT ELEVATION INSTALL ISOLATION BARRIER LINEAR FEET LEFT LAKE TAHOE BLVD MISCELLANEOUS NORTH NOTTO SCALE OVERHEAD PINE PROPERTY LINE POWER/UTILITY POLE PROPOSED PUBLIC UTILITY EASEMENT ROAD REFERENCE RIGHT-OF-WAY ROCK SLOPE PROTECTION RIGHT SOUTH OR SANITARY SEWER STORM DRAIN STORM DRAIN STORM DRAIN STORM DRAIN STORM DRAIN SOURE FEET SANITARY SEWER SEDIMENT TRAP OR STREET STATION SOUTH TAHOE PUBLIC UTILITY DISTRICT TAHOE REGIONAL PLANNING AGENCY TYPICAL
EP	EDGE OF PAVEMENT	STPUD	SOUTH TAHOE PUBLIC UTILITY DISTRICT
FES	FLARED END SECTION	USFS	UNITED STATES FOREST SERVICE
FF	FILTER FENCE	W	WEST OR WATER
FG	FINISHED GRADE	W/	WITH
FH	FIRE HYDRANT	W/O	WITHOUT

UTILITIES

CABLE TELEVISION NATURAL GAS ELECTRIC SEWER & WATER **TELEPHONE** STORM DRAIN

CHARTER COMMUNICATIONS, (775) 850-1290 SOUTHWEST GAS CO., (775) 887-2872 LIBERTY ENERGY, (530) 541-2040 SOUTH TAHOE PUD (530) 543-5247 AT&T (916) 453-6136 CITY OF SOUTH LAKE TAHOE, DPW (530) 542-6030

LEGEND

*NOTE: LEGEND PROVIDED ON SHEET SUPERCEDES THIS LEGEND EXISTING PROPOSED MAJOR CONTOUR FOOT TRAIL MINOR CONTOUR PIPE (MATERIAL AS NOTED) WATERS EDGE STRUCTURE BOUNDARY CUT PROPERTY LINE BOULDER TOE PROTECTION FENCELINE NEW FLOODPLAIN FOOT TRAIL SCOUR POOL WATER LINE POINT BAR SEWER LINE ROCK DISSIPATER GAS LINE RESTORED DUNES STORM DRAIN STORMWATER TREATMENT AREA ---EX ELEC---FLECTRIC LINE MAJOR CONTOUR AC PAVEMENT MINOR CONTOUR WOODEN FOOT BRIDGE TAHOE YELLOW CRESS UTILITY EASEMENT BOARDWALK POWER/UTILITY POLE BRIDGE UTILITY POLE & GUY ANCHOR FIRE HYDRANT +()+ GRADE CONTROL STRUCTURE DRAINAGE INLET LIGHT POLE NEW CHANNEL ALIGNMENT MANHOLE

UTILITY BOX

TREE, DIAMETER AND TYPE

EXISTING CHANNEL ALIGNMENT STATION NUMBER AND MARKER

€ 28*

0

HORIZONTAL AND VERTICAL CONTROL/PROJECTION

VERTICAL CONTROL IS NGVD 29; HORIZONTAL CONTROL IS CALIFORNIA STATE

PLANE, ZONE 2, NAD 83 (FEET):

I	EXISTING RIVER A
	FISHING ACCESS

RE-VEGETATION

XISTING RIVER ACCESS **FABILIZATION**



ADA ACCESSIBI E



OBSERVATION AREA



SELF-SERVICE VISITORS CENTER



PARKING



VIEWPOINT



DETAIL REF NUMBER SHEET NUMBER



UPPER TRUCKEE RIVER AND MARSH RESTORATION **PROJECT**

E.I.P. # 560



870 Emerald Bay Road, Suite 400 South Lake Tahoe, CA 96150 Tel: 530.543.5100 Fax: 530.543.5150



295 Highway 50, suite Zephyr Cove, NV 89448 Tel: 775.588.9069

GENERAL NOTES. ABBREVIATIONS. & LEGEND

ii

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DEVICIONS

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sheet <u>2</u> of <u>45</u>

date: 01/10/13

SCHEMATIC DESIGN PLANS & DETAILS NOT FOR CONSTRUCTION

CONSTRUCTION PHASING PLAN

ALTERNATIVE ONE

YFAR 1

- MOBILIZATION, INCLUDING HAUL ROAD AND STAGING AREA CONSTRUCTION, BMP INSTALLATION, SIGNAGE PLACEMENT.
- CONSTRUCTION OF HIGH FLOW CHANNEL (STA 1700 2900)

 CLEARING AND GRUBBING ALONG THE EAST SIDE OF THE UPPER TRUCKEE RIVER
- AND INSTALL A THE ISOLATION BARRIER (IB) EXCAVATE THE EXISTING EASTERN HIGH FLOW CHANNEL.
- REVEGETATE AND IRRIGATE ALL DISTURBED AREAS
- CONSTRUCTION OF NEW CHANNEL AND REGRADING OF LOWER WEST SIDE AREA (STA
- CLEARING AND GRUBBING OF THE LOWER WEST SIDE AREA TO ALLOW FOR
- RE-GRADING OF THE FLOODPLAIN AND INSTALL AN IB.
- RE-GRADE AND REVEGETATE THE LOWER WEST SIDE AREA
- A BULKHEAD/LEVEE SHALL BE CONSTRUCTED ACROSS THE SAILING LAGOON TO SEGREGATE IT FROM THE TAHOE KEYS MARINA.
- INSTALL AN IB ALONG THE EXISTING CHANNEL ALIGNMENT TO SEPARATE THE RIVER
- FROM ITS FLOODPLAIN, AND THE NEW CHANNEL SHALL BE CONSTRUCTED. • UPON COMPLETION OF ALL CHANNEL AND FLOODPLAIN WORK, ALL DISTURBED AREAS SHALL BE REVEGETATED AND IRRIGATED.

- EAST MEADOW AND APPURTENANCES

 RE-ROUTE THE EXISTING TRAIL ACROSS THE NEW BULKHEAD/LEVEE.
- AT THE END OF THE CONSTRUCTION SEASON, REMOVE IRRIGATION EQUIPMENT AND WINTERIZE THE SITE.

YEAR 2

- BANK STABILIZATION (STA 0-1300)

 CLEARING AND GRUBBING FOR CONSTRUCTION OF THE ROCK TOE PROTECTION AND SCOUR POOL AND INSTALLATION OF THE ISOLATION BARRIER.
- EXCAVATE FLOODPLAIN AND CONSTRUCT POINT BAR.
 REVEGETATE AND IRRIGATE NEW FLOODPLAIN AND DISTURBED AREAS.
- SEASONING OF HIGH FLOW CHANNEL (STA 1700 2900)
 IRRIGATION LINES WILL BE PLACED AND REVEGETATION INSPECTIONS WILL BE COMPLETED ON A MONTHLY BASIS.
- VERTICAL GRADE CONTROL STRUCTURES (STA 2900-6300)

 DEWATER THE CHANNEL IN SECTIONS AND CONSTRUCT VERTICAL GRADE CONTROLS.
- ALL DISTURBED AREAS WILL BE REVEGETATED AND IRRIGATED. RIVER MOUTH RE-CONFIGURATION (STA 9300-10700)
- CLEAR AND GRUB FOR CONSTRUCTION OF A GRADE CONTROL STRUCTURE.
- RESTORE THE DUNES OF EAST COVE BEACH.
- ALL DISTURBED AREAS SHALL BE REVEGETATED AND IRRIGATED.
- SEASONING OF NEW CHANNEL AND IRRIGATION OF LOWER WEST SIDE AREA (STA
- IRRIGATION LINES WILL BE PLACED AND REVEGETATION INSPECTIONS WILL BE COMPLETED ON A MONTHLY BASIS
- EAST MEADOW AND APPURTENANCES
- CONSTRUCT A CLASS I TRAIL SYSTEM THROUGH THE WOODED AREA NORTH OF HIGHLAND WOODS.
- CONSTRUCT A BOARDWALK AND OBSERVATION PLATFORMS ALONG THE EASTERN BOUNDARY.
- REMOVE FILL FROM BEHIND EAST BARTON BEACH.
- REVEGETATE AND IRRIGATE ALL DISTURBED AREAS.

YEAR 3

BANK STABILIZATION (STA 0-1300)

- IRRIGATION LINES WILL BE PLACED AND REVEGETATION INSPECTIONS WILL BE COMPLETED ON A MONTHLY BASIS.
- DIVERSION TO HIGH FLOW CHANNEL (STA 1700 2900)
- REMOVE IB AND PUT THE RIVER IN THE NEW ALIGNMENT. FLUSH THE NEW CHANNEL TO INITIATE THE FLOWS.
- PLACE IB TO THE OLD SECTION OF CHANNEL. BACKFILL OLD CHANNEL AND REVEGETATE. • INSTALL LATERAL GRADE CONTROL STRUCTURES AT THE UPSTREAM AND
- DOWNSTREAM ENDS OF THIS SECTION
- REMOVE IB AND REVEGETATE AND IRRIGATE ALL DISTURBED.
- VERTICAL GRADE CONTROL STRUCTURES (STA 2900-6300)

 IRRIGATION LINES WILL BE PLACED AND REVEGETATION INSPECTIONS WILL BE COMPLETED ON A MONTHLY BASIS.
- RESTORE THE SETTLING BASIN AND TKPOA CORPORATION YARD. ALL DISTURBED AREAS WILL BE REVEGETATED AND IRRIGATED.
- DIVERSION TO NEW CHANNEL AND ABANDONMENT OF EXISTING CHANNEL (STA
- PUT THE RIVER IN THE NEW ALIGNMENT AND MOVE IB TO ISOLATE THE OLD CHANNEL.
- DIVERT WATER FROM THE RIVER TO THE SAILING LAGOON TO ALLOW SETTLEMENT. THE NEW CHANNEL SECTION SHALL BE FLUSHED TO INITIATE THE FLOWS, AND THE OLD CHANNEL WILL BE BACKFILLED. REVEGETATED. AND IRRIGATED.
- CONVERGENCE OF NEW ALIGNMENT AND OLD ALIGNMENT WILL BE ARMORED WITH A COMBINATION OF VINYL SHEET PILE ROCK AND LARGE WOOD FLEMENTS. WILLOW STAKES WILL BE INCORPORATED INTO THESE ENGINEERED AREAS AND PROPAGATED SOD WILL BE PLACED ON TOP OF THE ARMORED PROTECTION.

SEASONING OF RIVER MOUTH RE-CONFIGURATION (STA 9300-10700

THE NEW CHANNEL AND FLOODPLAIN WILL BE ALLOWED TO ESTABLISH VEGETATION AND SEASONED. IRRIGATION LINES WILL BE PLACED AS SOON AS POSSIBLE AND REVEGETATION INSPECTIONS WILL BE ON A MONTHLY BASIS.

EAST MEADOW AND APPURTENANCES

• IRRIGATION LINES WILL BE PLACED AND REVEGETATION INSPECTIONS WILL BE COMPLETED ON A MONTHLY BASIS.

YEAR 4

- IRRIGATION AND VEGETATION MONITORING OF HIGH FLOW CHANNEL (STA 1700 2900) & VERTICAL GRADE CONTROL STRUCTURES (STA 2900-6300)& NEW CHANNEL AND LOWER WEST SIDE AREA (STA 6300-9300)
- IRRIGATION LINES WILL BE PLACED AND REVEGETATION INSPECTIONS WILL BE COMPLETED ON A MONTHLY BASIS. DIVERSION TO RIVER MOUTH RE-CONFIGURATION (STA 9300 -10700)
- PLACE THE RIVER IN THE NEW ALIGNMENT AND RE-INSTALLING IB TO ISOLATE THE
- OLD SECTION OF CHANNEL. THE NEW CHANNEL WILL BE FLUSHED SEVERAL TIMES, AND THE OLD CHANNEL WILL
- BE BACKFILLED, REVEGETATED, AND IRRIGATED.

EAST MEADOW AND APPURTENANCES

- INSTALL INTERPRETIVE SIGNAGE THROUGHOUT THE SITE.
 CONSTRUCT CLASS I BIKE TRAIL ALONG VENICE DRIVE.
- CONSTRUCT A VISITOR'S CENTER AND PARKING LOT AT THE END OF VENICE DRIVE.
- REVEGETATE AND IRRIGATE ALL DISTURBED AREAS

ALTERNATIVE TWO

YFAR 1

- MOBILIZATION, INCLUDING HAUL ROAD AND STAGING AREA CONSTRUCTION, BMP INSTALLATION, AND SIGNAGE PLACEMENT.
- CONSTRUCTION OF NEW GEOMORPHIC CHANNEL AND REGRADING OF LOWER WEST
- CLEARING AND GRUBBING ALONG THE UPPER TRUCKEE RIVER AND INSTALLATION OF
- · RE-GRADING OF THE LOWER WEST SIDE AREA.
- CONSTRUCT THE BULKHEAD/LEVEE ACROSS THE SAILING LAGOON.
- INSTALL AN IB ALONG THE EXISTING CHANNEL ON THE SIDE ADJACENT TO THE NEW CHANNEL, AND CONSTRUCT THE NEW CHANNEL
- UPON COMPLETION OF ALL CHANNEL AND FLOODPLAIN WORK, ALL DISTURBED AREAS SHALL BE REVEGETATED AND IRRIGATED.

EAST MEADOW AND APPURTENANCES

RE-ROUTE THE EXISTING TRAIL ACROSS THE NEW BULKHEAD/LEVEE.

YEAR 2

BANK STABILIZATION (STA 0-2000)

- CLEARING AND GRUBBING FOR CONSTRUCTION OF THE ROCK TOE PROTECTION AND SCOUR POOL AND INSTALL THE IB.
- CONSTRUCT ROCK TOE PROTECTION.
- EXCAVATE SECONDARY CHANNEL MOUTH AND CONSTRUCT POINT BAR.
- EXCAVATE FLOODPLAIN LOCATIONS REVEGETATE AND IRRIGATE NEW FLOODPLAIN AND DISTURBED AREAS AT THE
- CONCLUSION OF CONSTRUCTION. EASONING OF NEW GEOMORPHIC CHANNEL AND VEGETATION ESTABLISHMENT OF
- LOWER WEST SIDE AREA (STA 1300 9300) IRRIGATION LINES WILL BE PLACED AND REVEGETATION INSPECTIONS WILL BE
- COMPLETED ON A MONTHLY BASIS. RIVER MOUTH RE-CONFIGURATION (STA 9300-10700)
- CLEARING AND GRUBBING ALONG THE UPPER TRUCKEE RIVER AND INSTALLATION OF THE IB.
- CONSTRUCT NEW CHANNEL WITH VERTICAL GRADE CONTROLS
- THE DUNES AREA SHALL BE RESTORED ACCORDING TO THE PLANS AND SPECIFICATIONS.
- ALL DISTURBED AREAS SHALL BE REVEGETATED AND IRRIGATED. EAST MEADOW AND APPURTENANCES
- CONSTRUCT OBSERVATION PLATFORMS ALONG THE EASTERN BOUNDARY.
- REMOVE FILL FROM BEHIND FAST BARTON BEACH
- REVEGETATE AND IRRIGATE ALL DISTURBED AREAS.

YEAR 3

- BANK STABILIZATION (STA 0-2000)

 IRRIGATION LINES WILL BE PLACED AND REVEGETATION INSPECTIONS WILL BE COMPLETED ON A MONTHLY BASIS.
- DIVERSION TO NEW GEOMORPHIC CHANNEL; ABANDONMENT OF EXISTING CHANNEL; VEGETATION ESTABLISHMENT OF LOWER WEST SIDE AREA (STA 2000 9300)
- REMOVE IB AND PUT RIVER IN THE NEW ALIGNMENT. INSTALL IB TO ISOLATE FOR BACKFILL OF OLD RIVER ALIGNMENT.
- THE OLD CHANNEL WILL BE BACKFILLED. REVEGETATED. AND IRRIGATED. WHERE THE NEW ALIGNMENT AND EXISTING ALIGNMENT CONVERGE WILL BE ARMORED WITH A COMBINATION OF VINYL SHEET PILE, ROCK AND LARGE WOOD ELEMENTS. WILLOW STAKES WILL BE INCORPORATED INTO THESE ENGINEERED AREAS AND PROPAGATED SOD WILL BE PLACED ON TOP OF THE ARMORED
- PROTECTION. CONSTRUCT A VERTICAL GRADE CONTROL STRUCTURE ON THE UPSTREAM END OF THIS SECTION.
- STORMWATER TREATMENT AREAS SHALL BE CONSTRUCTED IN THE FLOODPLAIN NEAR THE TKPOA YARD.
- RESTORE THE SETTLING BASIN AND TKPOA CORPORATION YARD. ALL DISTURBED AREAS SHALL BE REVEGETATED AND IRRIGATED
- SEASONING OF RIVER MOUTH RE-CONFIGURATION (STA 9300-10700)& EAST MEADOW
- IRRIGATION LINES WILL BE PLACED AND REVEGETATION INSPECTIONS WILL BE COMPLETED ON A MONTHLY BASIS.

- IRRIGATION AND VEGETATION MONITORING OF NEW GEOMORPHIC CHANNEL; EXISTING CHANNEL; LOWER WEST SIDE AREA (STA 2000 9300) AS EARLY AS POSSIBLE, AN INSPECTION WILL BE COMPLETED TO EVALUATE THE
- CONDITION OF IMPROVEMENTS IRRIGATION LINES WILL BE PLACED AS SOON AS POSSIBLE AND REVEGETATION INSPECTIONS WILL BE COMPLETED ON A MONTHLY BASIS.
- CONSTRUCT FISHING PLATFORM DIVERSION INTO RIVER MOUTH RE-CONFIGURATION (STA 9300-
- THIS YEAR THE RIVER SHALL BE PUT IN THE NEW ALIGNMENT BY REMOVING THE IB AND RE-INSTALLING IT TO ISOLATE THE OLD SECTION OF CHANNEL.
- THE NEW CHANNEL SECTION SHALL BE FLUSHED SEVERAL TIMES TO INITIATE THE FLOWS, AND THE OLD CHANNEL WILL BE BACKFILLED, REVEGETATED, AND IRRIGATED. SEASONING OF RIVER MOUTH RE-CONFIGURATION (STA 9300-10700) & EAST MEADOW. AND LOWER WEST SIDE AREA (STA 6700-9300) EAST MEADOW AND APPURTENANCES INSTALL INTERPRETIVE SIGNAGE THROUGHOUT THE SITE
- REVEGETATE AND IRRIGATE ALL DISTURBED AREAS.

ALTERNATIVE THREE

YFAR 1

- MOBILIZATION, INCLUDING HAUL ROAD AND STAGING AREA CONSTRUCTION, BMP INSTALLATION, SIGNAGE PLACEMENT.
- CONSTRUCTION OF NEW GEOMORPHIC PILOT CHANNEL AND REGRADING OF LOWER WEST SIDE AREA (STA 3000-9300)
- CLEARING AND GRUBBING ALONG THE UPPER TRUCKEE RIVER TO INSTALL AN IB
- EXCAVATE A PILOT CHANNEL.
- REGRADE THE LOWER WEST SIDE AREA.
 A BULKHEAD SHALL BE CONSTRUCTED ACROSS THE SAILING LAGOON TO SEGREGATE IT FROM THE TAHOE KEYS MARINA.
- INSTALL IB TO ISOLATE THE UPPER TRUCKEE RIVER FROM ITS FLOODPLAIN IN THE VICINITY OF THE NEW PILOT CHANNEL.
- EXCAVATE THE NEW PILOT CHANNEL (~1800')
- THE CONTRACTOR SHALL INSTALL A VERTICAL GRADE CONTROL
- THE NEW FLOODPLAIN, CHANNEL AND ANY DISTURBED AREAS WILL BE
- REVEGETATED AND IRRIGATED. EAST MEADOW AND APPURTENANCES
- RE-ROUTE THE EXISTING TRAIL ACROSS THE NEW BULKHEAD LEVEE.

YEAR 2

- CONSTRUCTION OF BANK STABILIZATION AND OVERBANK CONVEYANCE (STA 0-1300)

 CLEARING AND GRUBBING FOR CONSTRUCTION OF THE ROCK TOE PROTECTION AND SCOUR POOL AND INSTALLATION OF THE ISOLATION BARRIER.
- EXCAVATE FLOODPLAIN AND CONSTRUCT POINT BAR.
- CONSTRUCT TWO 48" CMP ARCH PIPES BENEATH HWY 50 TO THE WEST OF THE BRIDGE STRUCTURE. CONSTRUCT A ROCK HEADWALL UPSTREAM, AND A ROCK DISSIPATER SHALL BE
- INSTALLED AT THE DOWNSTREAM END.
- REVEGETATE AND IRRIGATE NEW FLOODPLAIN AND DISTURBED AREAS. CONSTRUCTION OF LOWERED FLOODPLAIN (STA 1700 - 3000 CLEARING AND GRUBBING ALONG THE UPPER TRUCKEE RIVER TO ALLOW FOR
- CONSTRUCTION OF NEW FLOODPLAIN EXCAVATE THE EXISTING FLOODPLAIN. REVEGETATION AND IRRIGATION OF NEW FLOODPLAIN AND DISTURBED AREAS SHALL COMMENCE AT THE CONCLUSION OF CONSTRUCTION
- SEASONING OF NEW GEOMORPHIC PILOT CHANNEL AND LOWER WEST SIDE AREA (STA 3000-9300)
- IRRIGATION LINES WILL BE PLACED AND REVEGETATION INSPECTIONS WILL BE COMPLETED ON A MONTHLY BASIS.
- CONSTRUCTION OF RIVER MOUTH RE-CONFIGURATION (STA 9300-10700 CLEARING AND GRUBBING WILL BE COMPLETED TO ALLOW FOR INSTALLATION OF THE GRADE CONTROL STRUCTURE.
- INSTALL AN IB AND CONSTRUCT THE GRADE CONTROL STRUCTURE RESTORE THE DUNES AT EAST COVE BEACH
- ALL DISTURBED AREAS SHALL BE REVEGETATED AND IRRIGATED. EAST MEADOW AND APPURTENANCES
- CONSTRUCT TRAILS AND BOARDWALKS, AND OBSERVATION PLATFORMS ALONG THE EASTERN BOUNDARY.
- CONSTRUCT LOOP TRAIL THROUGH WOODS NORTH OF HIGHLAND WOODS.
- REVEGETATE AND IRRIGATE ALL DISTURBED AREAS.

- IRRIGATION AND VEGETATION ESTABLISHMENT OF BANK STABILIZATION & OVERBANK CONVEYANCE (STA 0-1300) • AS EARLY AS POSSIBLE, AN INSPECTION WILL BE COMPLETED TO EVALUATE THE
- CONDITION OF IMPROVEMENTS. IRRIGATION LINES WILL BE PLACED AS SOON AS POSSIBLE AND REVEGETATION INSPECTIONS WILL BE COMPLETED ON A MONTHLY BASIS
- IRRIGATION AND VEGETATION ESTABLISHMENT OF LOWERED FLOODPLAIN (STA 1300 -• AS EARLY AS POSSIBLE, AN INSPECTION WILL BE COMPLETED TO EVALUATE THE
- CONDITION OF IMPROVEMENTS.

 IRRIGATION LINES WILL BE PLACED AS SOON AS POSSIBLE AND REVEGETATION INSPECTIONS WILL BE COMPLETED ON A MONTHLY BASIS
- DIVERSION TO NEW GEOMORPHIC PILOT CHANNEL AND ABANDONMENT OF EXISTING THIS YEAR. THE RIVER WILL BE PUT IN THE NEW ALIGNMENT BY REMOVING THE ISOLATION BARRIER AND RE-INSTALLING IT TO ISOLATE THE OLD SECTION OF
- CHANNEL. THE RIVER FLOW WILL BE DIVERTED TO THE PILOT CHANNEL AND ALLOWED TO FIND ITS OWN PATH BACK TO LAKE TAHOE. AFTER THE WATER IS DIVERTED TO THE NEW CHANNEL, THE OLD CHANNEL WILL BE BACKELLED REVEGETATED AND IRRIGATED
- BACKFILLED, REVEGETATED, AND IRRIGATED.

 CONVERGENCE OF THE NEW ALIGNMENT AND OLD ALIGNMENT CONVERGE WILL BE

 CONVERGENCE OF THE NEW ALIGNMENT AND OLD ALIGNMENT CONVERGE WILL BE

 IRRIGATION LINES WILL BE PLACED AND REVEGETATION INSPECTIONS WILL BE STAKES WILL BE INCORPORATED INTO THESE ENGINEERED AREAS AND PROPAGATED SOD WILL BE PLACED AS NEEDED ON TOP OF THE ARMORED
- PROTECTION
- AND APPURTENANCES

 IRRIGATION LINES WILL BE PLACED AND REVEGETATION INSPECTIONS WILL BE

COMPLETED ON A MONTHLY BASIS

- YFAR 4 IRRIGATION AND VEGETATION ESTABLISHMENT OF NEW GEOMORPHIC PILOT
- CHANNEL, EXISTING CHANNEL, AND LOWER WEST SIDE AREA (STA 3000-9300)

 IRRIGATION LINES WILL BE PLACED AND REVEGETATION INSPECTIONS WILL BE COMPLETED ON A MONTHLY BASIS.
- STORMWATER TREATMENT AREAS SHALL BE CONSTRUCTED IN THE FLOODPLAIN. NEAR THE TKPOA YARD AND THE TKPOA YARD SHALL BE RESTORED ACCORDING TO THE PLANS AND SPECIFICATIONS. ALL DISTURBED AREAS SHALL BE REVEGETATED AND IRRIGATED.

THE NEW CHANNEL WILL BE FLUSHED SEVERAL TIMES TO INITIATE THE FLOWS. AND

- DIVERSION TO RIVER MOUTH RE-CONFIGURATION (STA 9300 -10700).

 THIS YEAR THE RIVER WILL BE PUT IN THE NEW ALIGNMENT BY REMOVING THE ISOLATION BARRIER AND RE-INSTALLING IT TO ISOLATE THE OLD SECTION OF
- THE OLD CHANNEL WILL BE BACKFILLED, REVEGETATED, AND IRRIGATED EAST MEADOW AND APPURTENANCES • INSTALL INTERPRETIVE SIGNAGE THROUGHOUT THE SITE CONSTRUCT SELF-SERVE KIOSK AT THE END OF VENICE DRIVE

ALTERNATIVE FOUR

YFAR 1

 MOBILIZATION, INCLUDING HAUL ROAD AND STAGING AREA CONSTRUCTION, BMP INSTALLATION, AND SIGNAGE PLACEMENT.

- CONSTRUCTION OF NEW CHANNEL AND REGRADING OF LOWER WEST SIDE AREA (STA
- CLEARING AND GRUBBING ALONG THE UPPER TRUCKEE RIVER TO ALLOW FOR INSTALLATION OF THE IB, EXCAVATE THE NEW CHANNEL AND REGRADE THE LOWER WEST SIDE AREA
- INSTALL THE IB TO ISOLATE THE UPPER TRUCKEE RIVER FROM ITS FLOODPLAIN IN THE VICINITY OF LOWER WEST SIDE.
- THE NEW FLOODPLAIN, CHANNEL AND ANY DISTURBED AREAS WILL BE REVEGETATED. AND IRRIGATED.
- CONSTRUCTION OF RIVER MOUTH RE-CONFIGURATION (STA 9300-10700)

 CLEARING AND GRUBBING WILL BE COMPLETED TO ALLOW FOR RE-CONFIGURATION
- OF THE CHANNEL MOUTH.
- INSTALL AN IB AND DEWATER THE CHANNEL. REGRADE THE MOUTH AREA THE AND USE LOCAL CUT AND FILL TO REGRADE THE
- MOUTH AREA TO THE LINES AND GRADES DEPICTED IN THE DRAWINGS. WHEN CONSTRUCTION IS COMPLETE, THE WATER WILL BE RETURNED TO THE
- CHANNEL AND THE TEMPORARY DIVERSION WILL BE REMOVED ALL DISTURBED AREAS SHALL BE REVEGETATED AND IRRIGATED FOR ONE YEAR.

- CONSTRUCTION OF BANK STABILIZATION & INSET FLOODPLAIN (STA 0-1300)

 CLEARING AND GRUBBING FOR CONSTRUCTION OF THE ROCK TOE PROTECTION AND
- SCOUR POOL AND INSTALLATION OF THE ISOLATION BARRIER. CONSTRUCT ROCK TOE PROTECTION • EXCAVATE FLOODPLAIN AND CONSTRUCT POINT BAR.
- REVEGETATE AND IRRIGATE NEW FLOODPLAIN AND DISTURBED AREAS.
 CONSTRUCTION OF INSET FLOODPLAIN (STA 1300 6700)
 CLEARING AND GRUBBING ALONG THE UPPER TRUCKEE RIVER TO ALLOW FOR
- CONSTRUCTION OF NEW FLOODPLAIN.
- EXCAVATE THE EXISTING FLOODPLAIN. REVEGETATION AND IRRIGATION OF NEW FLOODPLAIN AND DISTURBED AREAS.
 SEASONING OF NEW CHANNEL AND LOWER WEST SIDE AREA (STA 6700-9300) & SEASONING OF RIVER MOUTH RE-CONFIGURATION (STA 9300
- IRRIGATION LINES WILL BE PLACED AND REVEGETATION INSPECTIONS WILL BE COMPLETED ON A MONTHLY BASIS. EAST MEADOW AND APPURTENANCES
- CONSTRUCT TRAILS AND BOARDWALKS, AND OBSERVATION PLATFORMS ALONG THE EASTERN BOUNDARY ACCORDING TO THE PLANS AND SPECIFICATIONS.

 CONSTRUCT A PERIMETER CLASS I BIKE TRAIL ALONG THE SOUTHERN BORDER OF

REVEGETATE AND IRRIGATE ALL DISTURBED AREAS

YEAR 3 SEASONING OF BANK STABILIZATION & INSET FLOODPLAIN (STA 0-1300) & SEASONING

- OF INSET FLOODPLAIN (STA 1300 6700)

 IRRIGATION LINES WILL BE PLACED AND REVEGETATION INSPECTIONS WILL BE COMPLETED ON A MONTHLY BASIS. DIVERSION TO NEW CHANNEL AND ABANDONMENT OF EXISTING CHANNEL (STA
- THIS YEAR. THE RIVER WILL BE PUT IN THE NEW ALIGNMENT BY REMOVING THE ISOLATION BARRIER AND RE-INSTALLING IT TO ISOLATE THE OLD SECTION OF CHANNEL AS EACH SECTION OF NEW CHANNEL IS BROUGHT ON-LINE, THE NEW CHANNEL
- SECTION SHALL BE FLUSHED SEVERAL TIMES TO INITIATE THE FLOWS, AND THE OLD CHANNEL WILL BE BACKFILLED, REVEGETATED, AND IRRIGATED. THE LOCATIONS WHERE THE NEW ALIGNMENT AND EXISTING ALIGNMENT CONVERGE WILL BE ARMORED WITH A COMBINATION OF ROCK AND LARGE WOOD FLEMENTS. WILLOW STAKES WILL BE INCORPORATED INTO THESE ENGINEERED AREAS AND PROPAGATED SOD WILL BE PLACED AS NEEDED ON TOP OF THE ARMORED
- PROTECTION. THE NEW FLOODPLAIN, ABANDONED CHANNEL, AND ANY DISTURBED AREAS WILL BE IRRIGATED AND MONITORED FOR ONE YEAR FOLLOWING COMPLETION OF
- <u>DIVERSION TO RIVER MOUTH RE-CONFIGURATION (STA 9300 -10700)</u>
 THIS YEAR THE RIVER WILL BE PUT IN THE NEW ALIGNMENT BY REMOVING THE ISOLATION BARRIER AND RE-INSTALLING IT TO ISOLATE THE OLD SECTION OF CHANNEL.

THE NEW CHANNEL WILL BE FLUSHED SEVERAL TIMES TO INITIATE THE FLOWS, AND

THE OLD CHANNEL WILL BE BACKFILLED, REVEGETATED, AND IRRIGATED.

COMPLETED ON A MONTHLY BASIS.

- YEAR 4 RRIGATION AND VEGETATION ESTABLISHMENT OF NEW CHANNEL, EXISTING CHANNEL
- IRRIGATION LINES WILL BE PLACED AND REVEGETATION INSPECTIONS WILL BE RRIGATION AND VEGETATION ESTABLISHMENT OF RIVER MOUTH RE-CONFIGURATION • IRRIGATION LINES WILL BE PLACED AND REVEGETATION INSPECTIONS WILL BE
- COMPLETED ON A MONTHLY BASIS. FAST MEADOW AND APPURTENANCES

COMPLETED ON A MONTHLY BASIS

INSTALL INTERPRETIVE SIGNAGE THROUGHOUT THE SITE. . CONSTRUCT SELF-SERVE KIOSK AT THE END OF VENICE DRIVE

> SCHEMATIC DESIGN PLANS & DETAILS NOT FOR CONSTRUCTION



UPPER TRUCKEE RIVER AND MARSH RESTORATION **PROJECT**

E.I.P. # 560





870 Emerald Bay Road, Suite 400

South Lake Tahoe, CA 96150

295 Highway 50, suite 1 Zephyr Cove, NV 89448 Tel: 775.588.9069

iii

CONSTRUCTION


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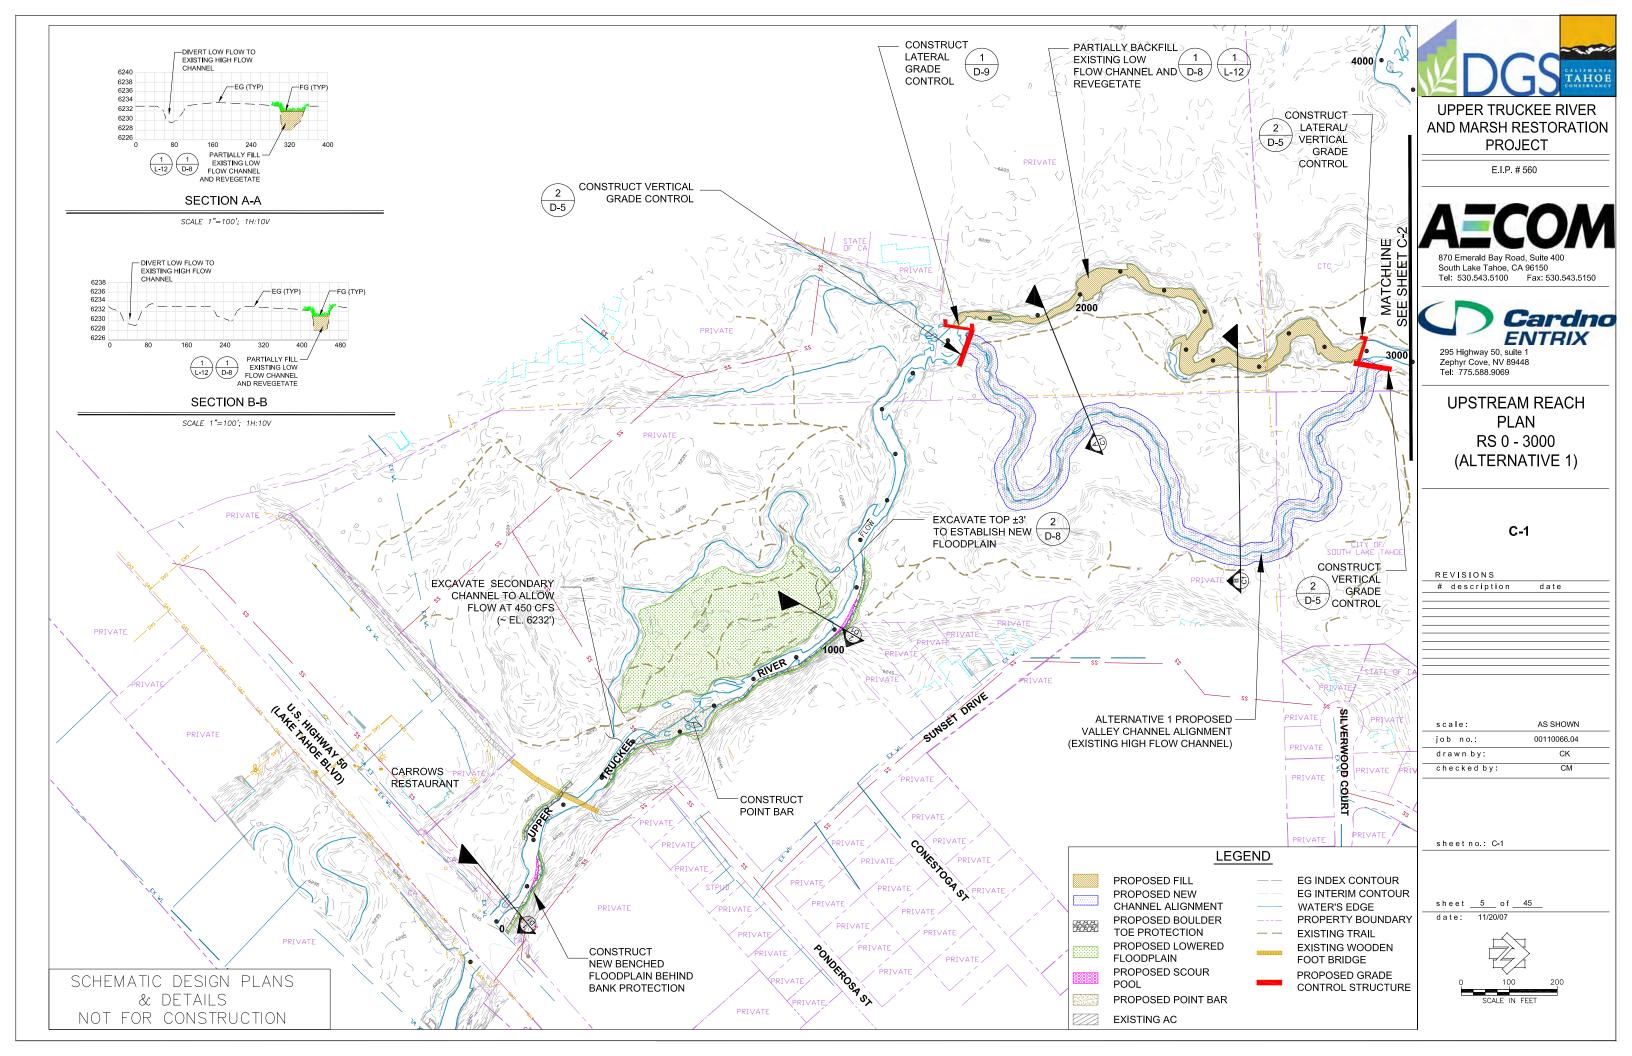
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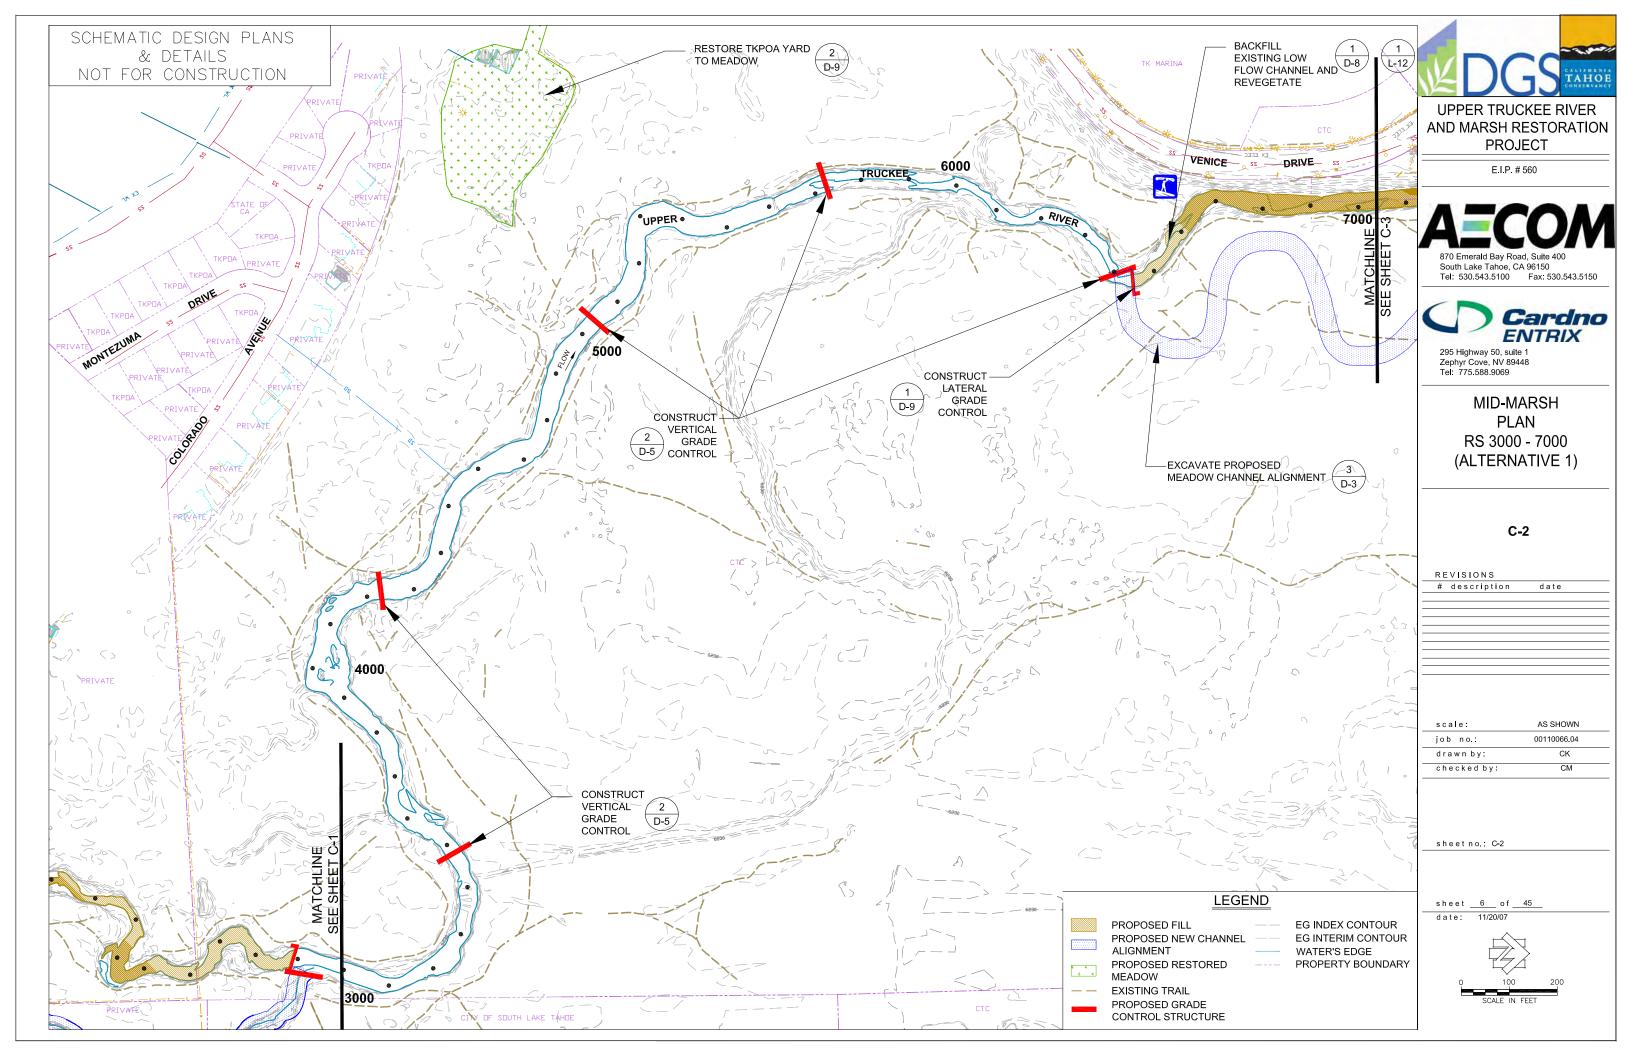
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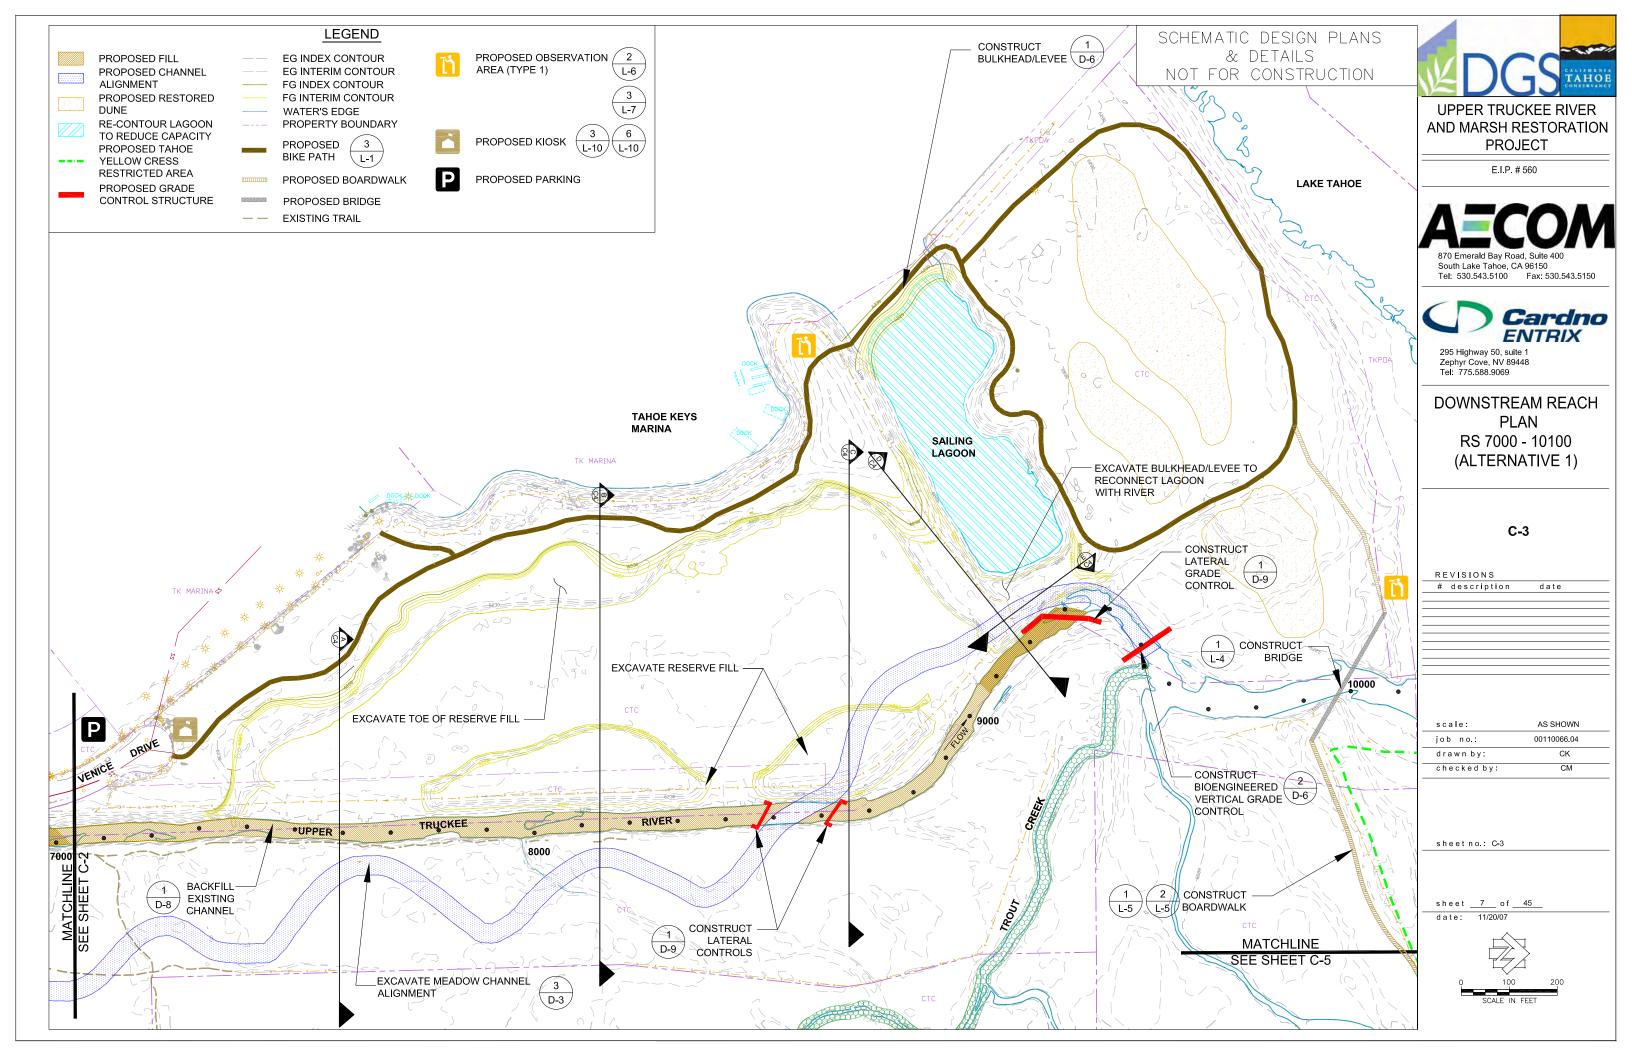
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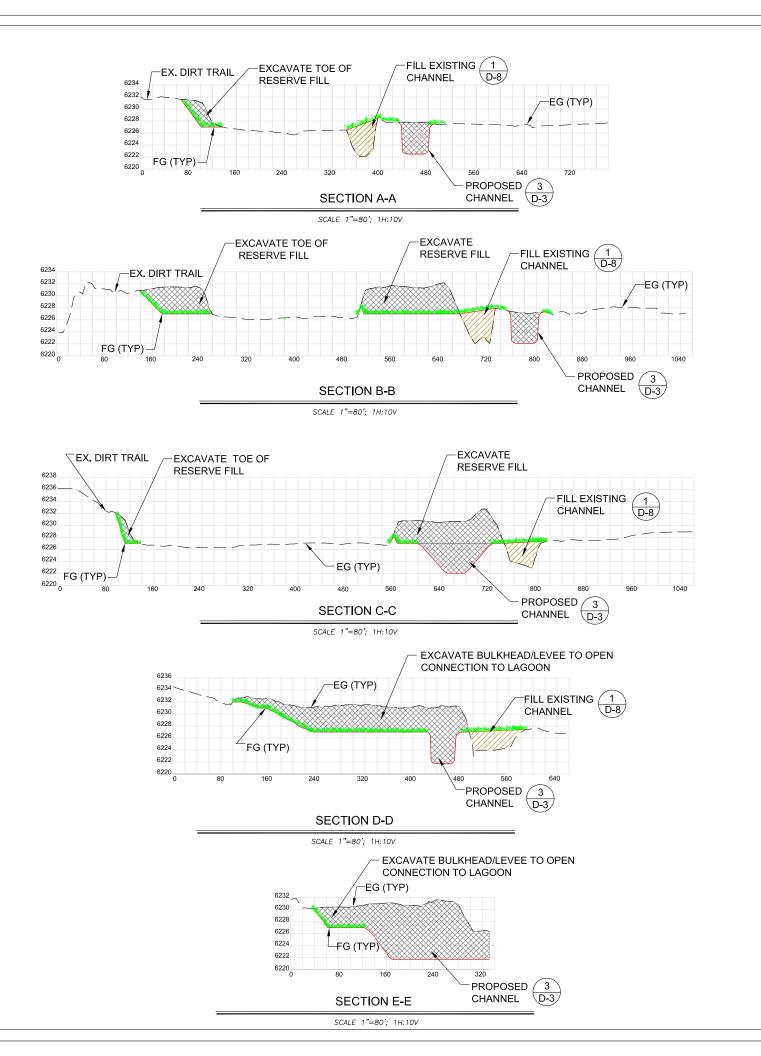
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Tel: 530.543.5100 Fax: 530.543.5150



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DOWNSTREAM REACH RS 7000 - 10700 CROSS SECTIONS (ALTERNATIVE 1)

C-4

REVISIONS

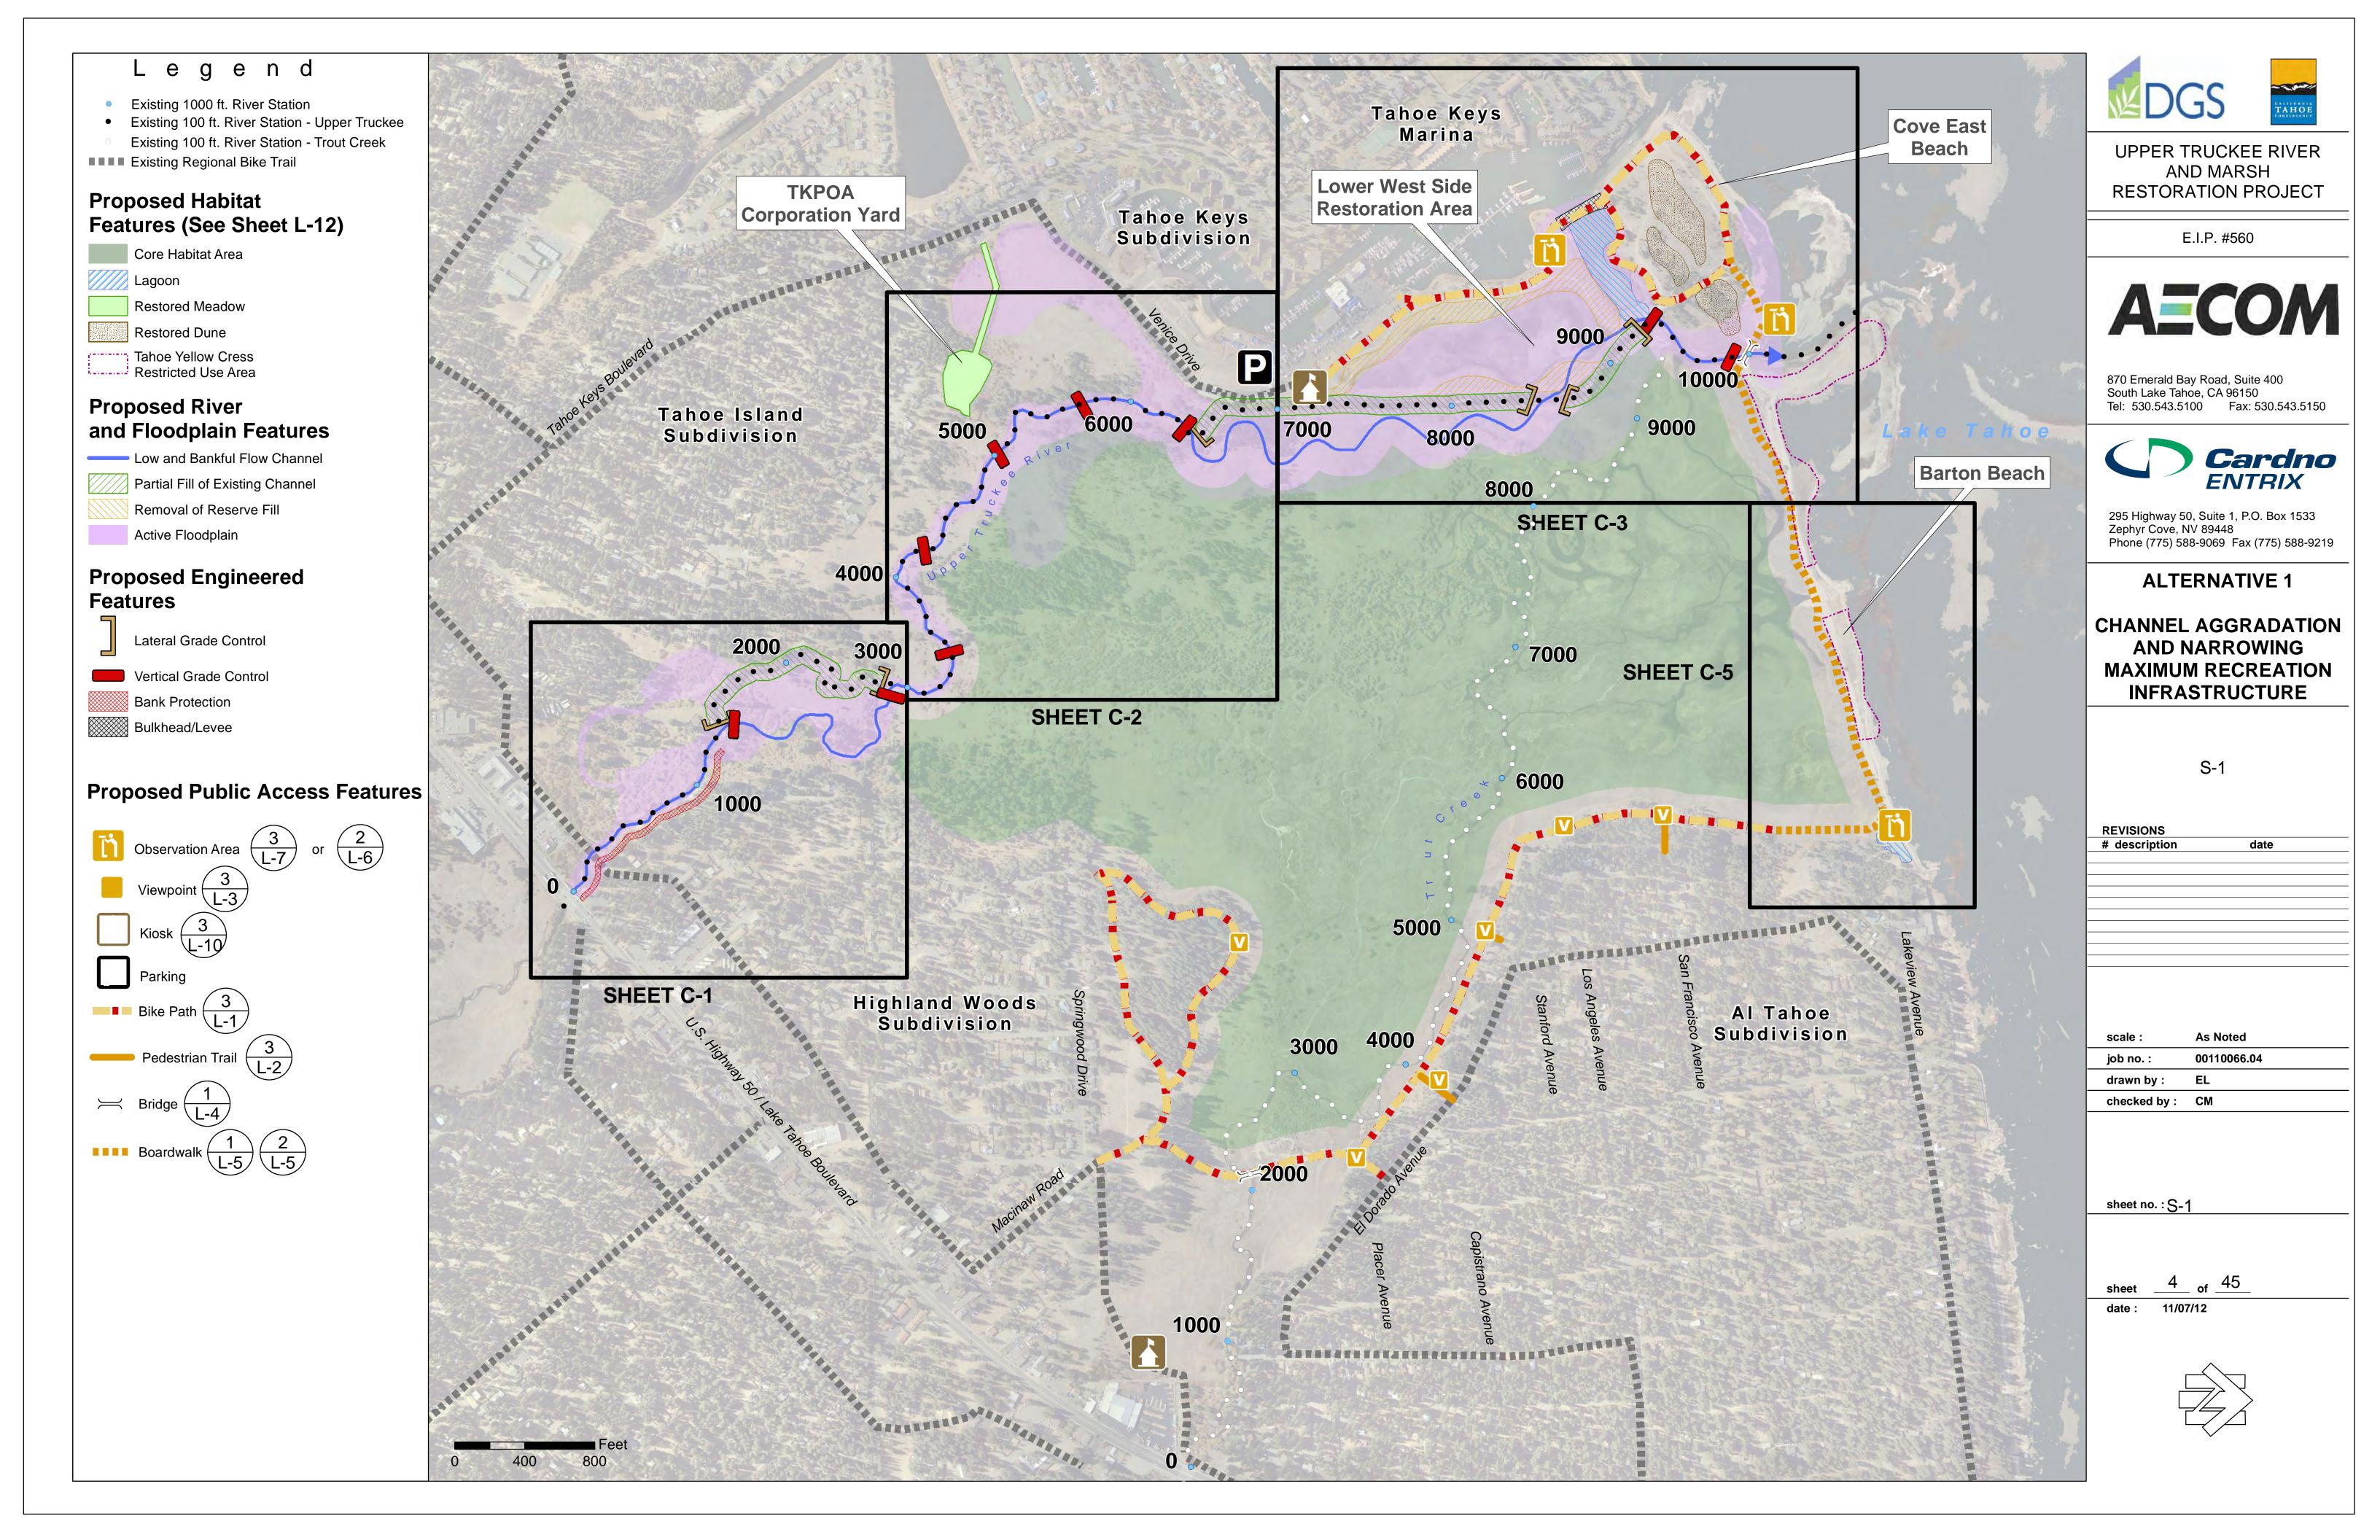description date

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sheet <u>8</u> of <u>45</u> date: 11/20/07

LEGEND


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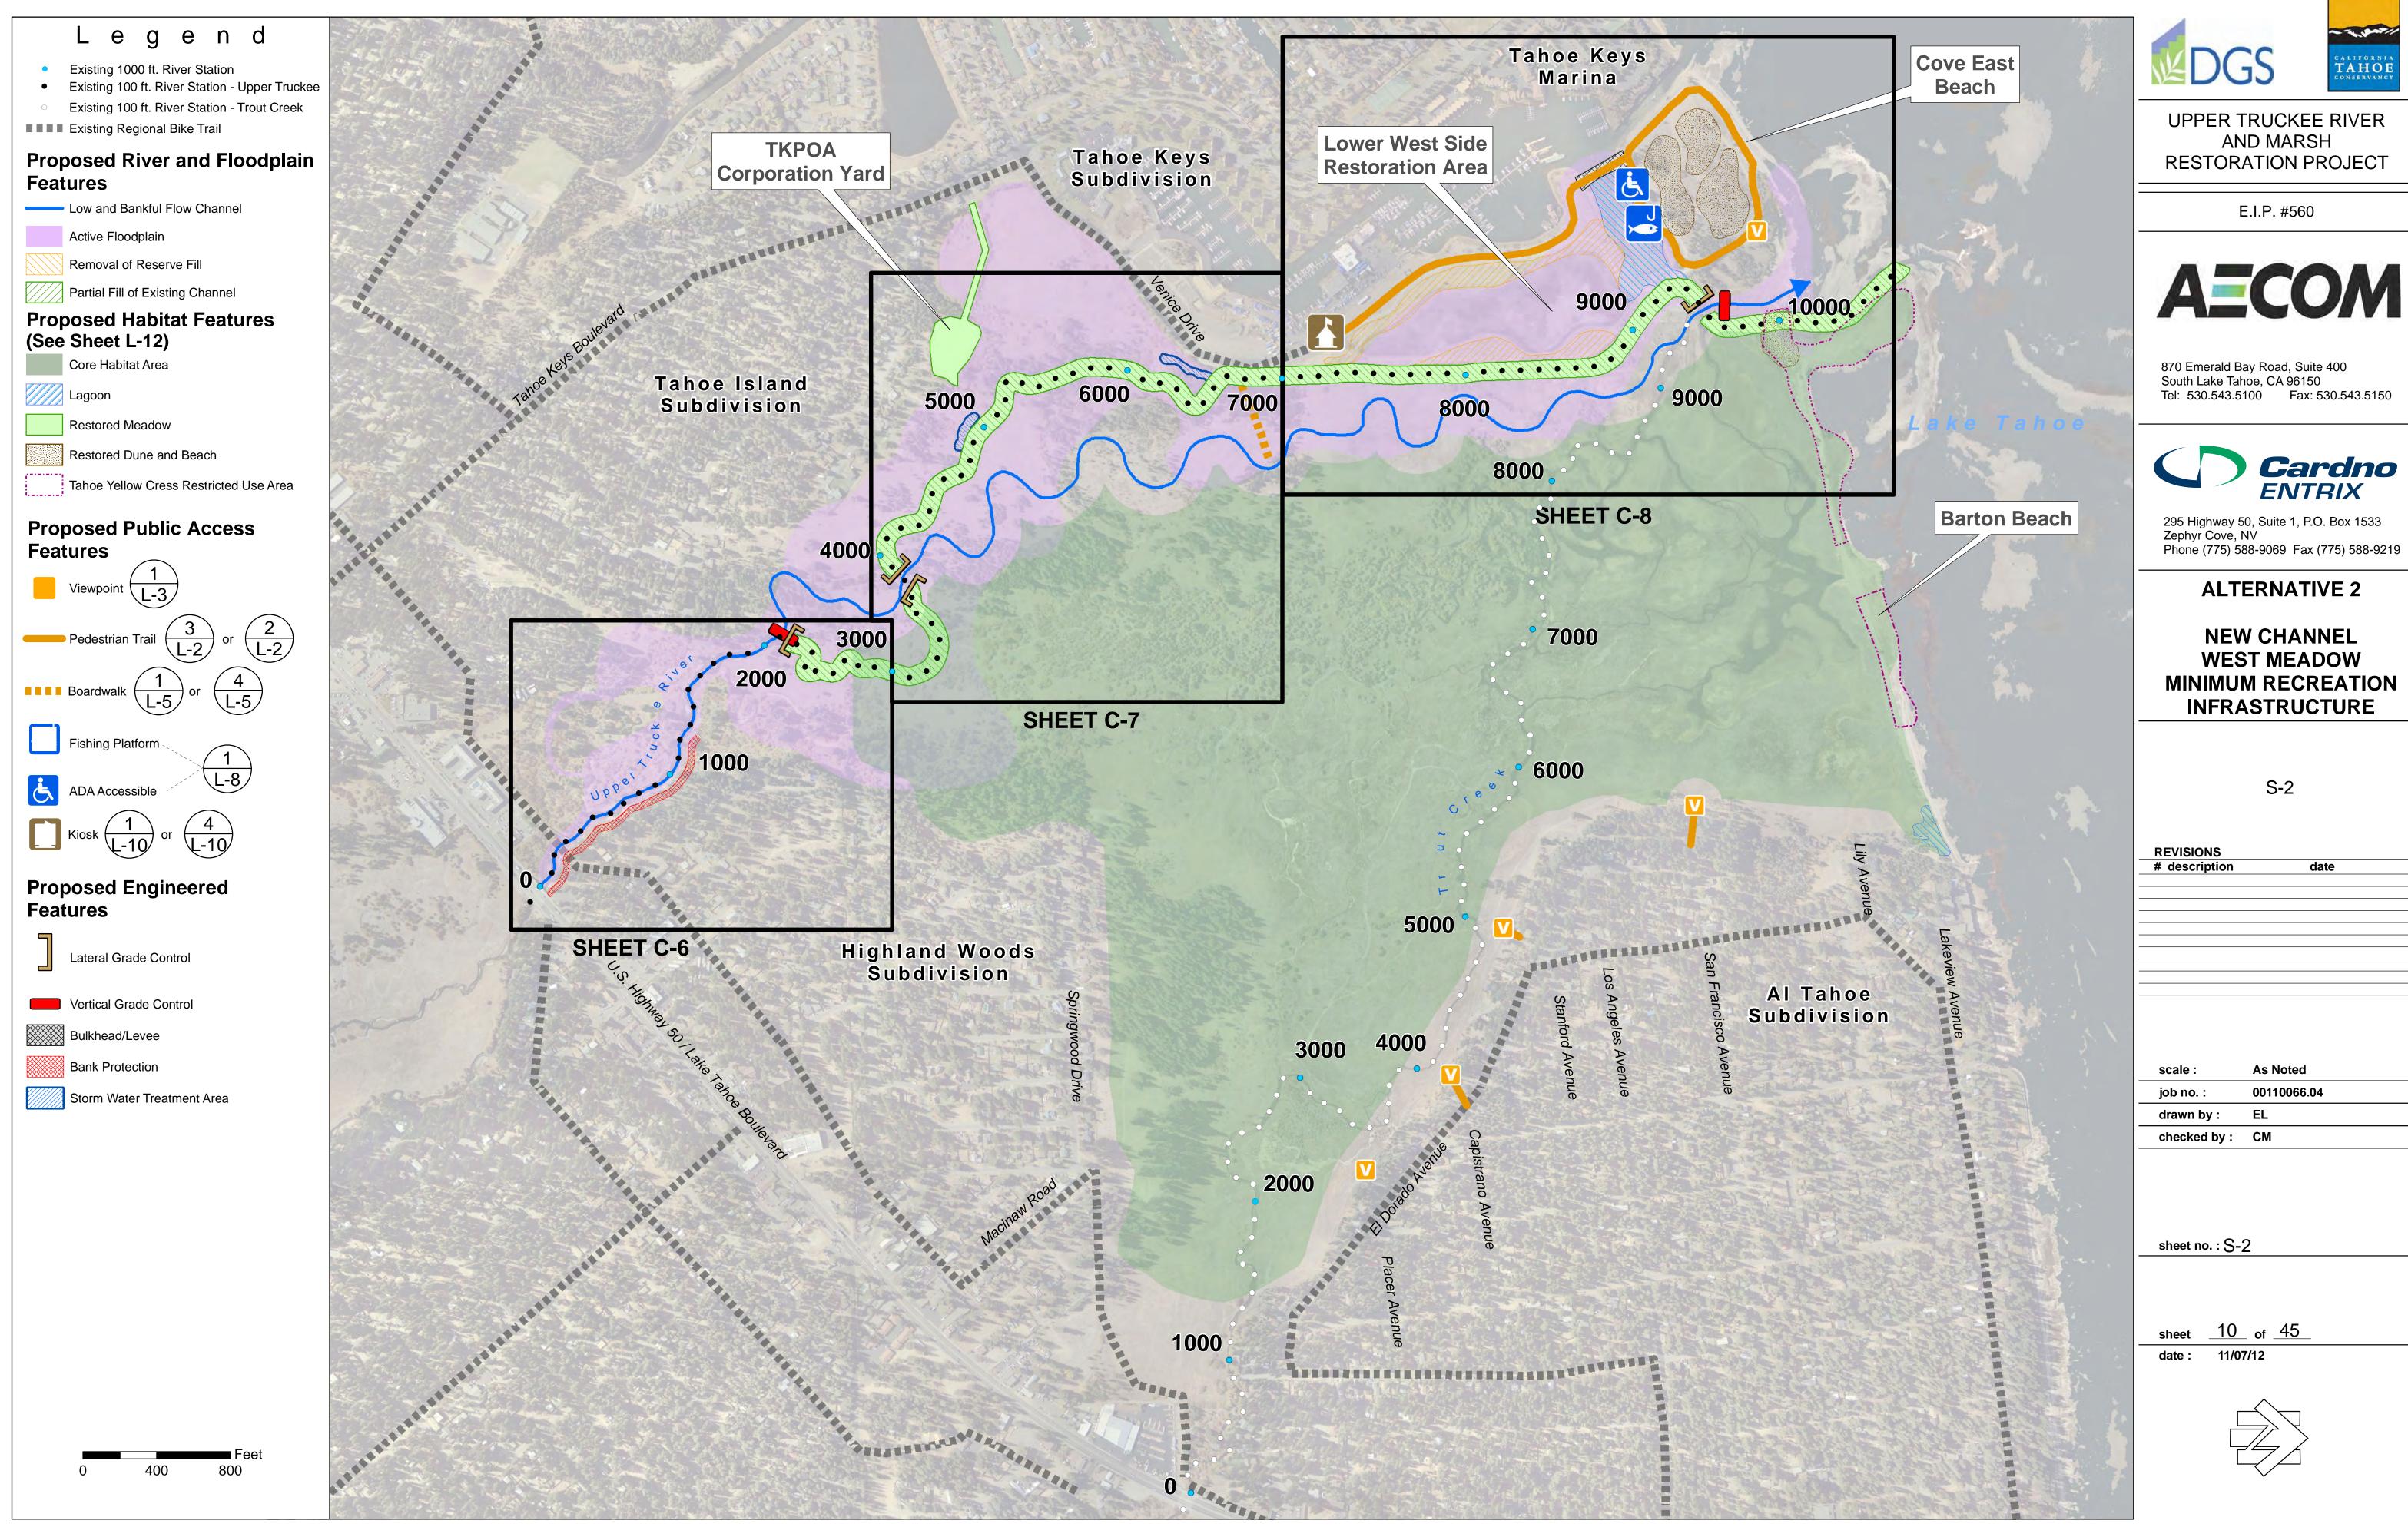
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SCHEMATIC DESIGN PLANS & DETAILS NOT FOR CONSTRUCTION











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& DETAILS
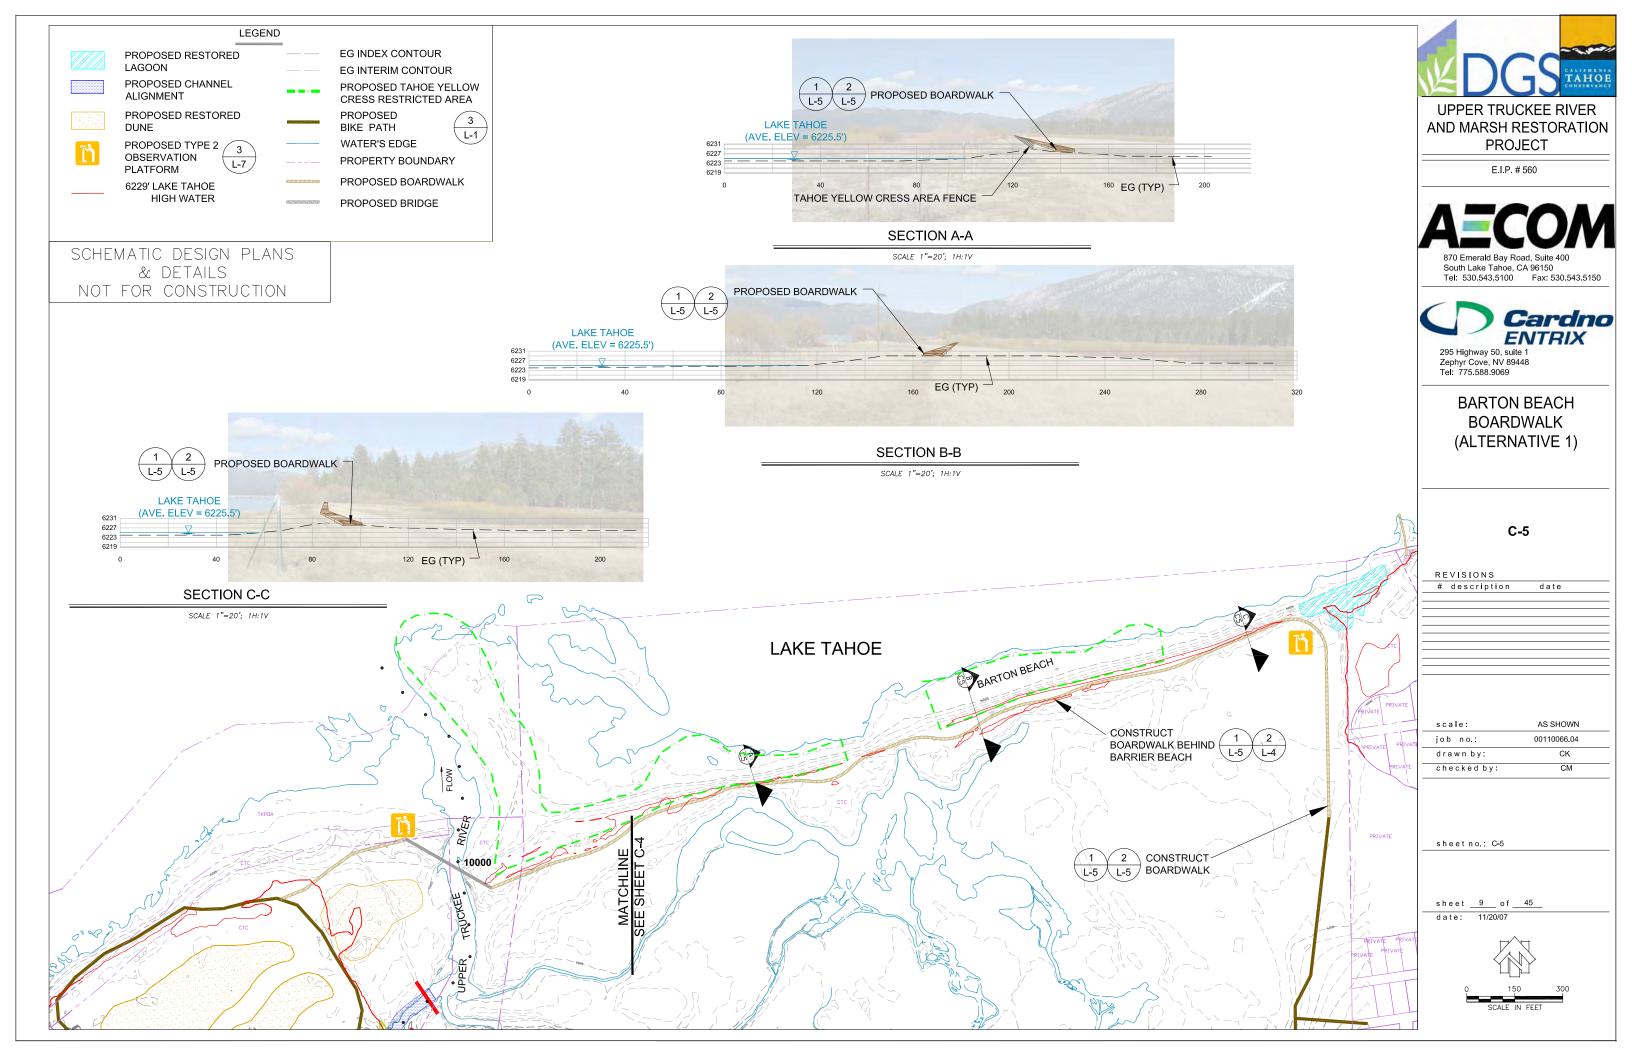
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DOWNSTREAM REACH RS 7000 - 10700 **CROSS SECTIONS** (ALTERNATIVE 2)

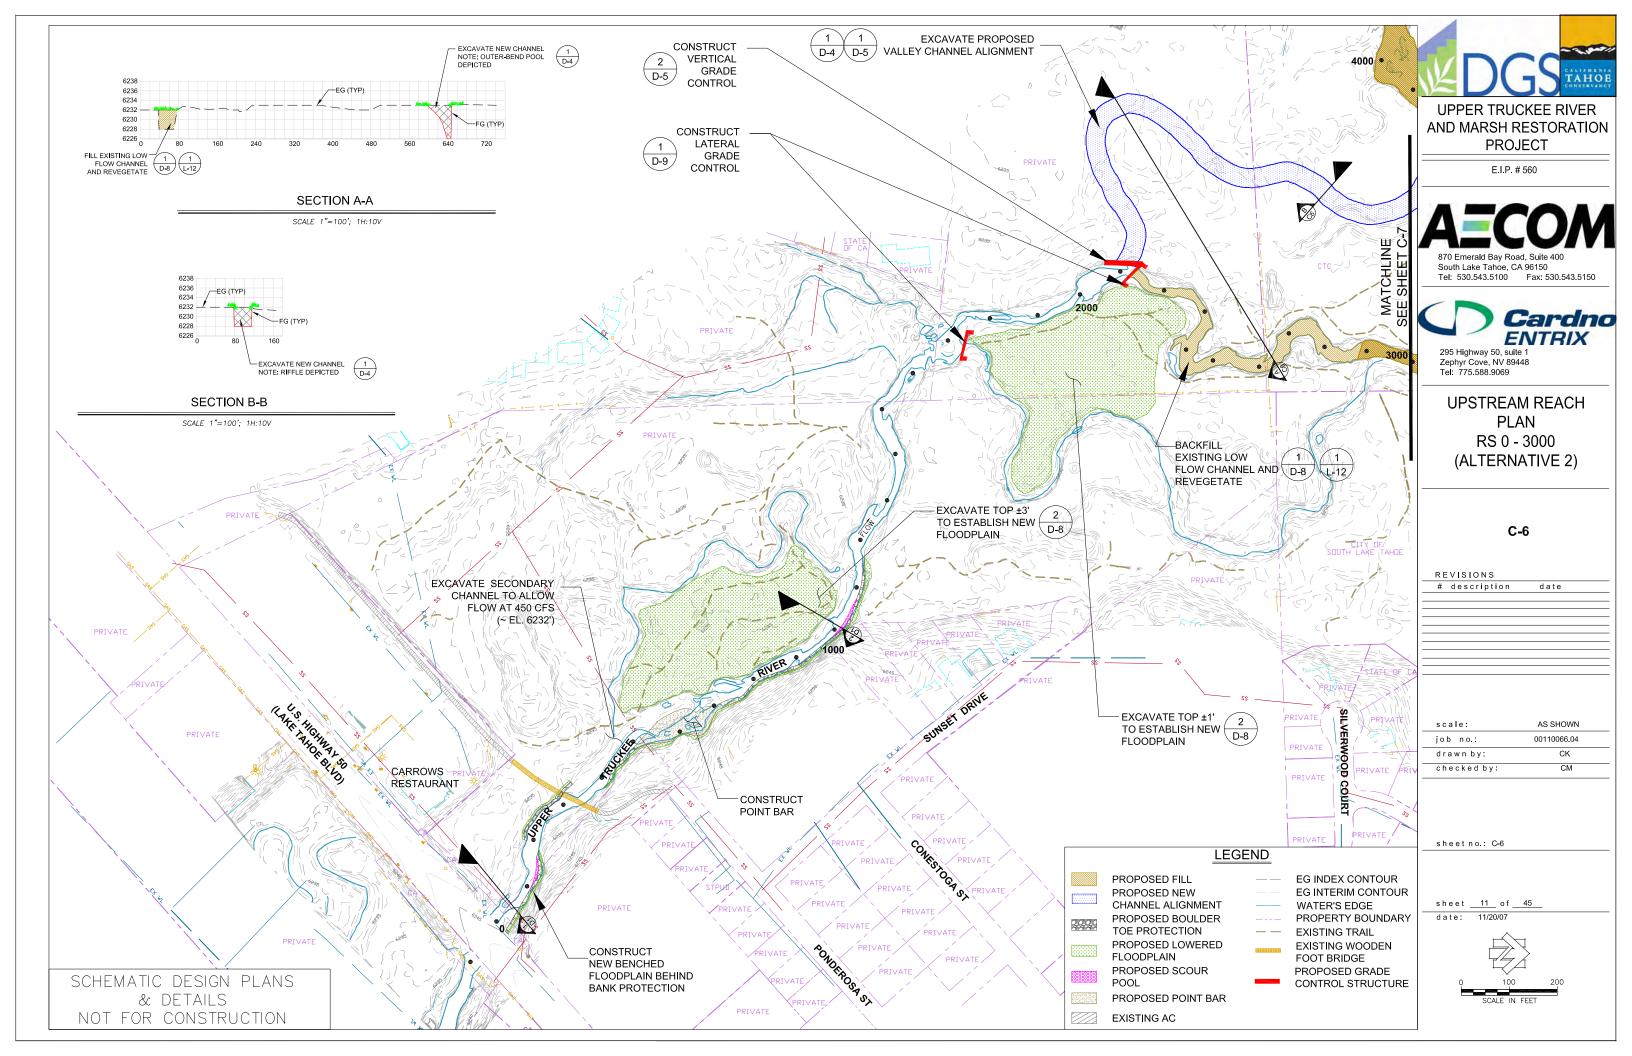C-9

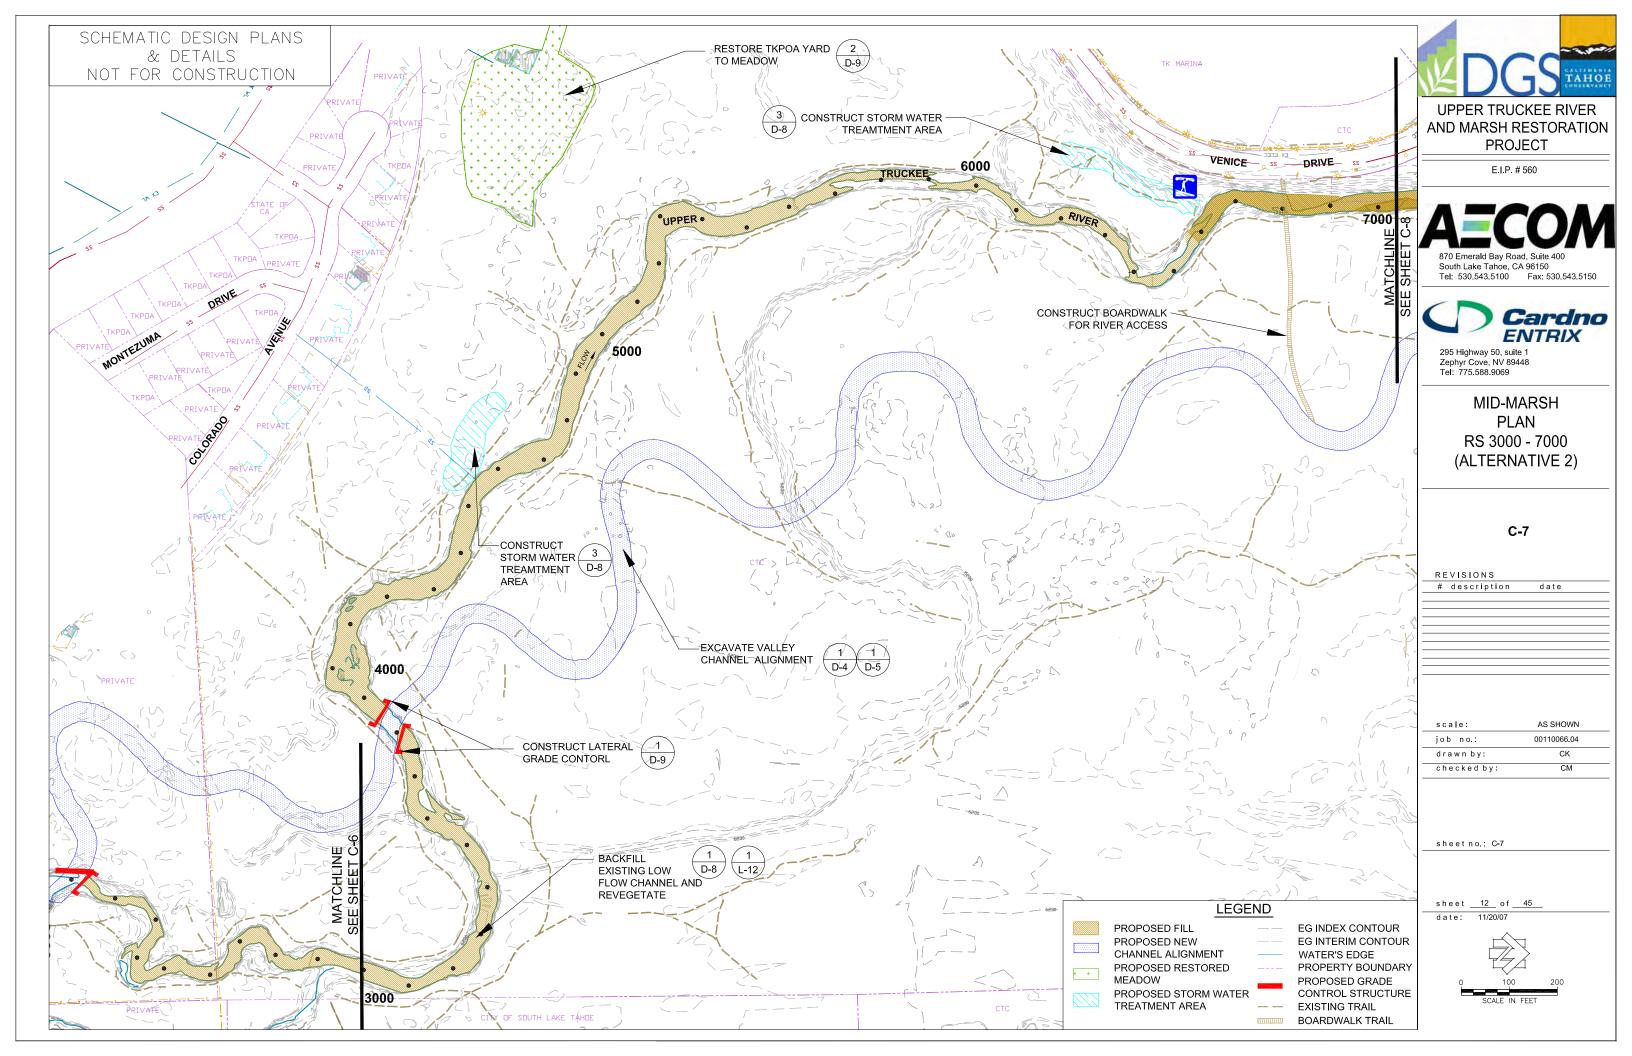REVISIONS # description date
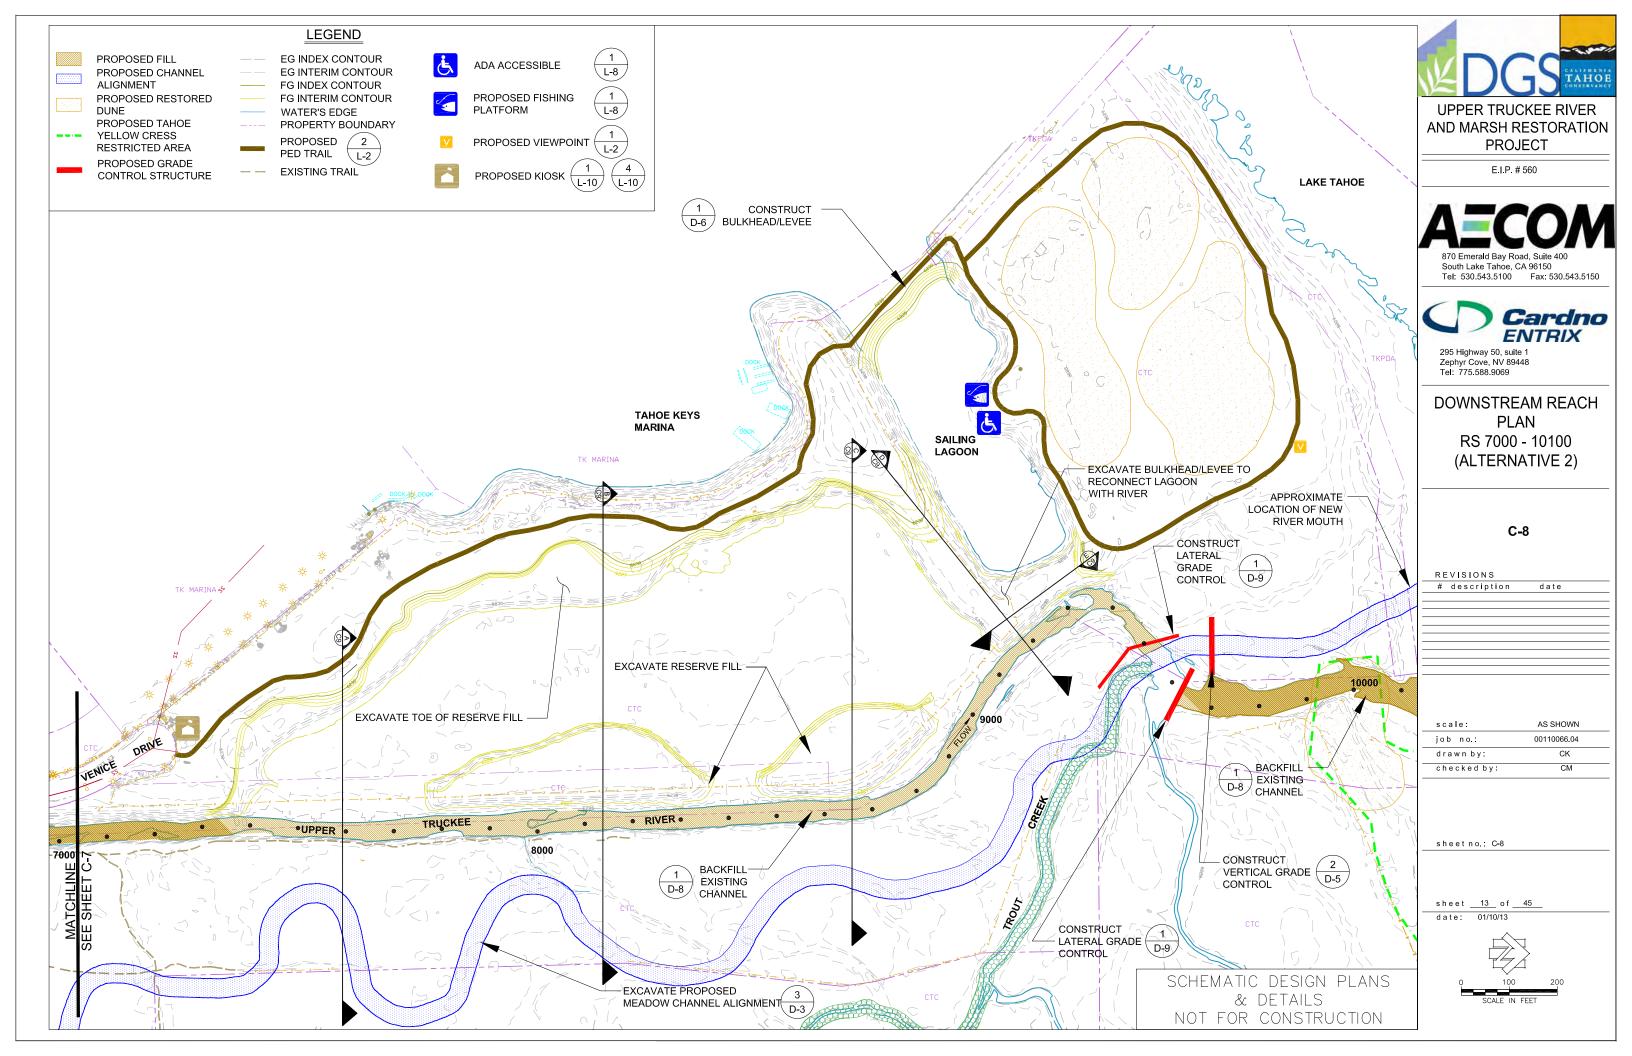
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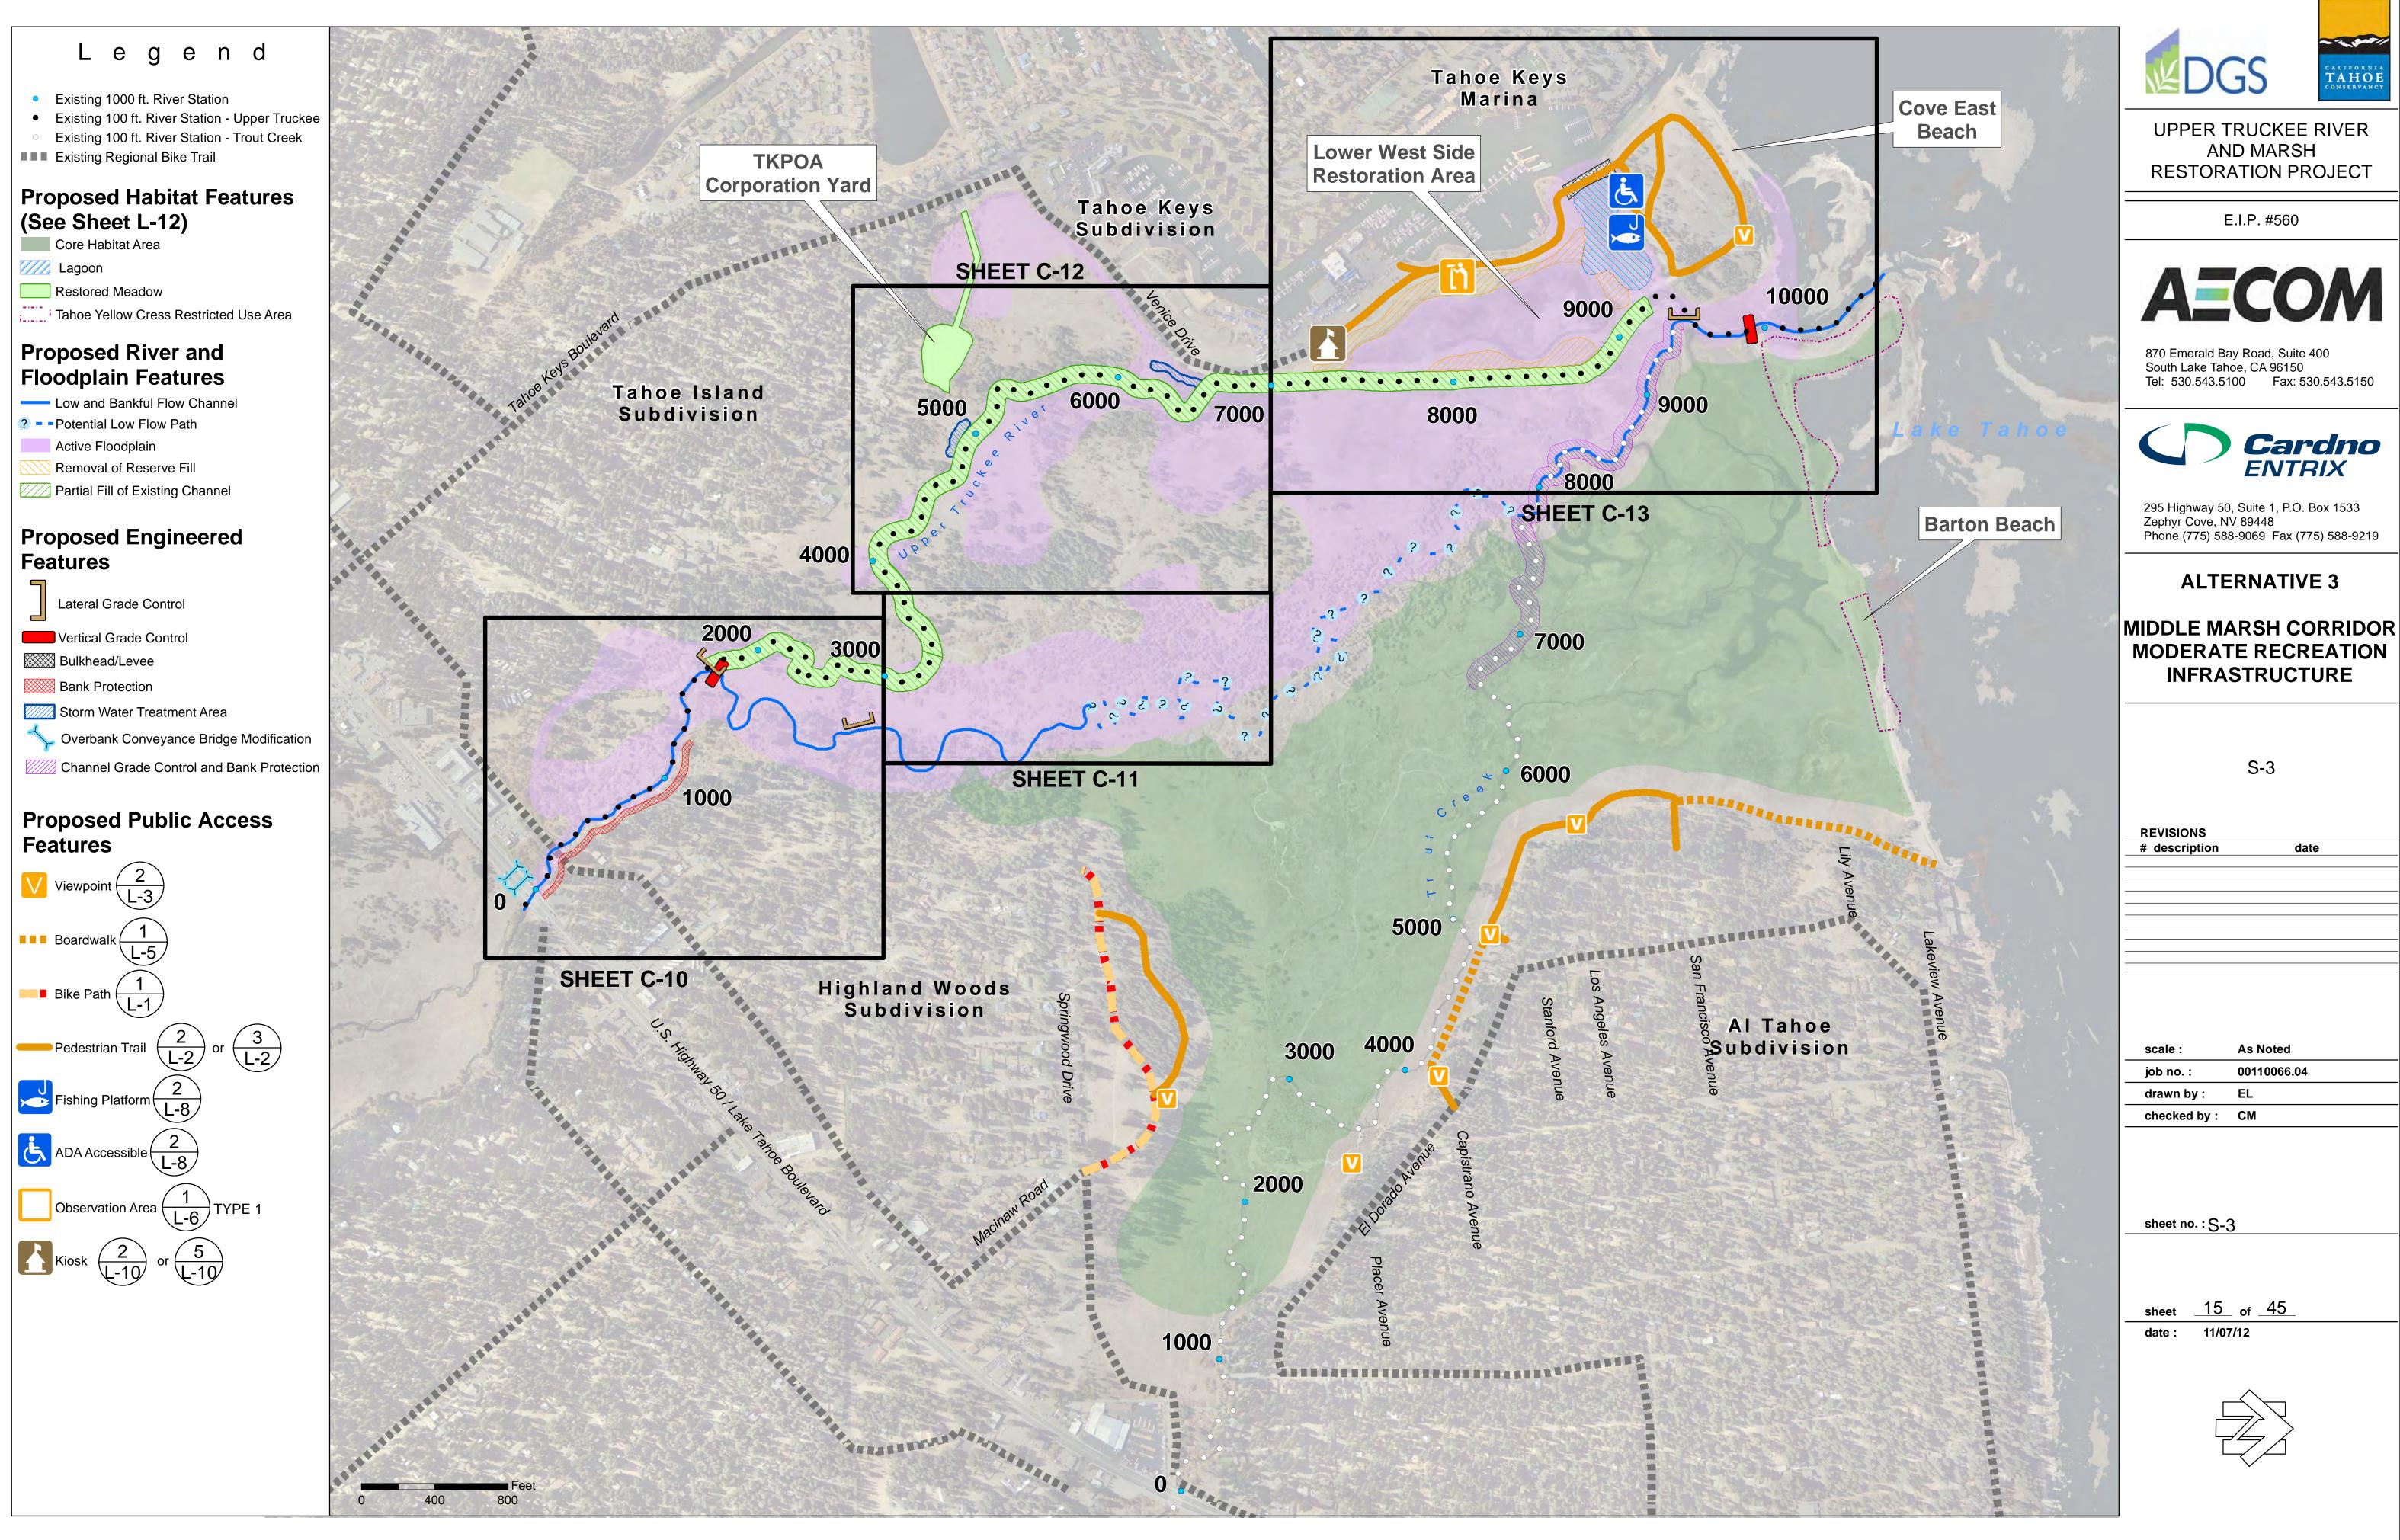
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LEGEND

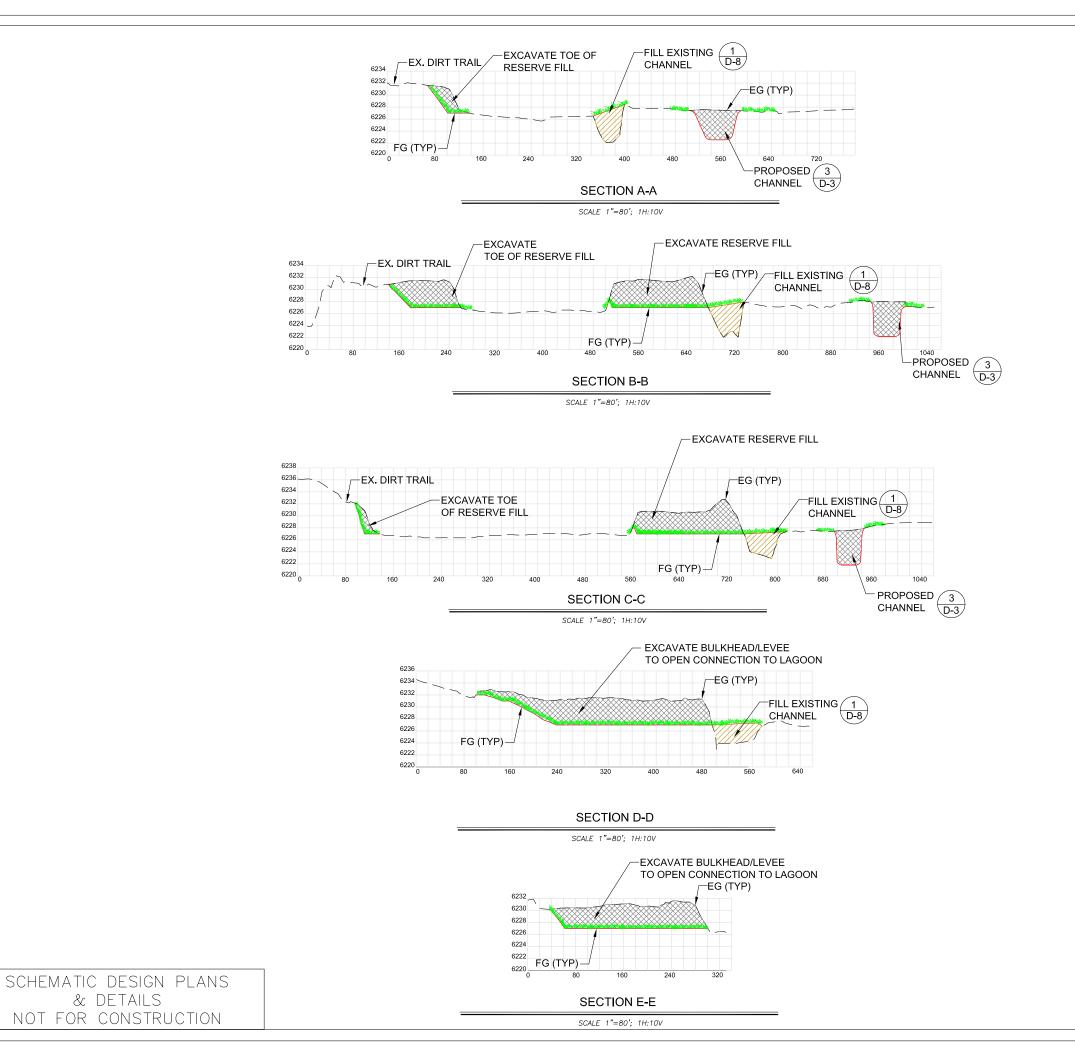
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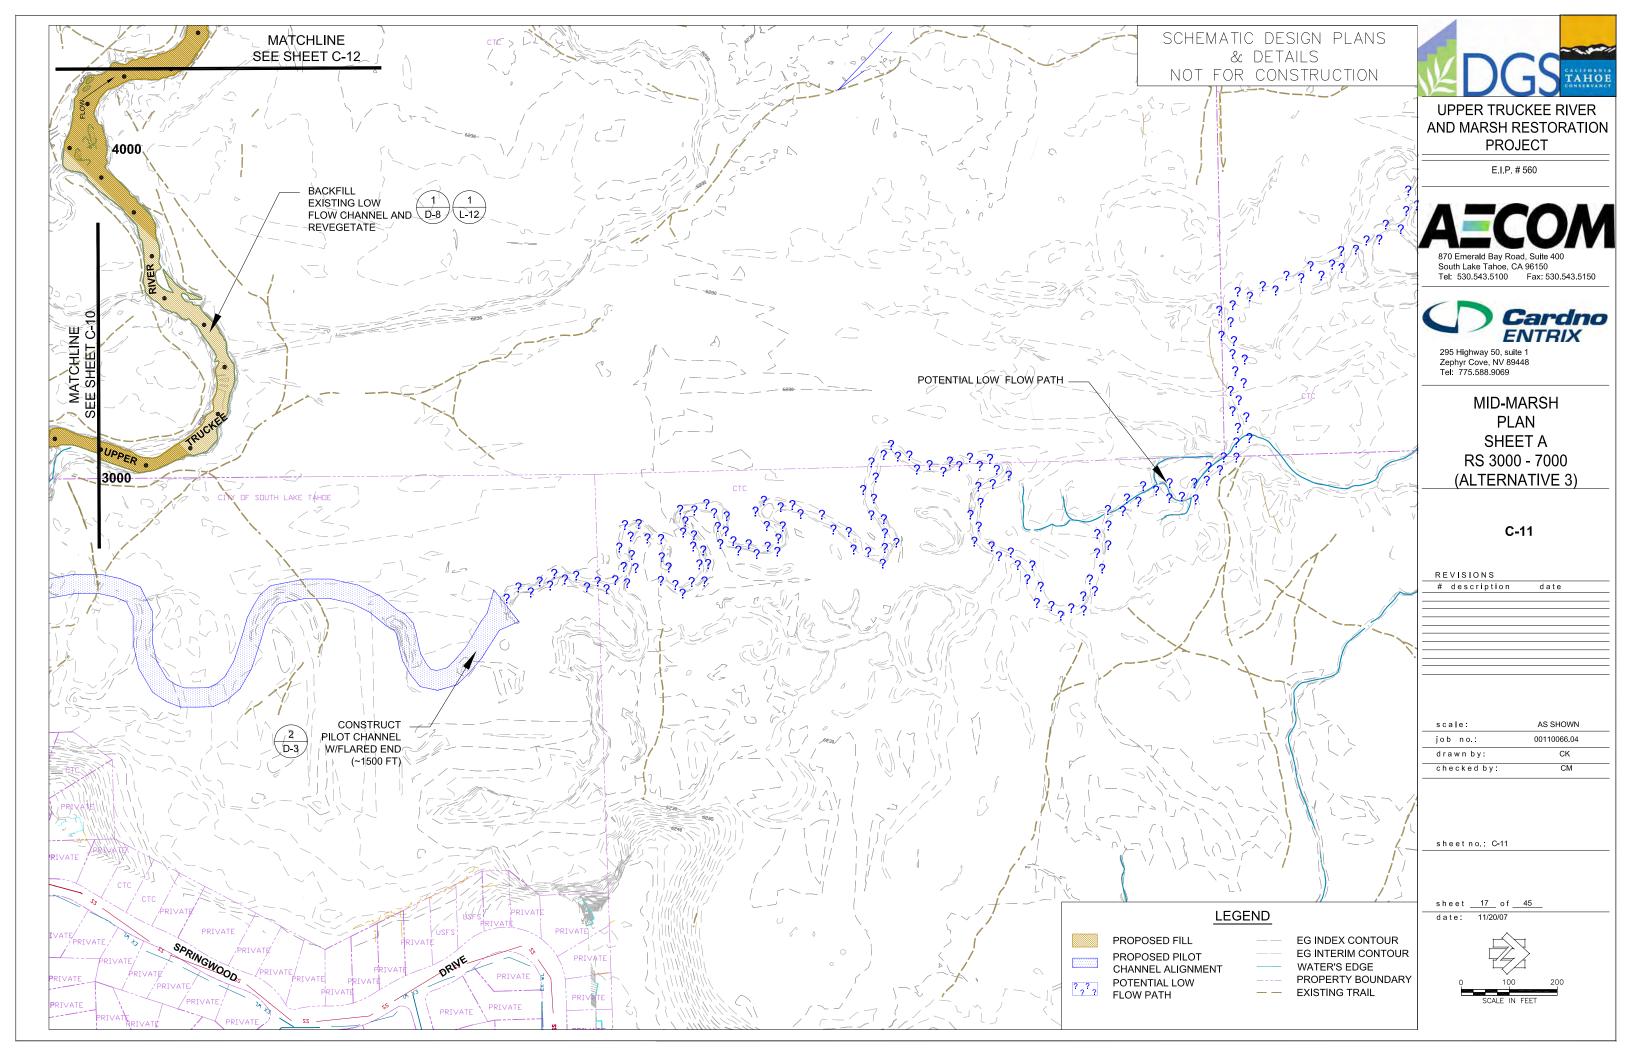
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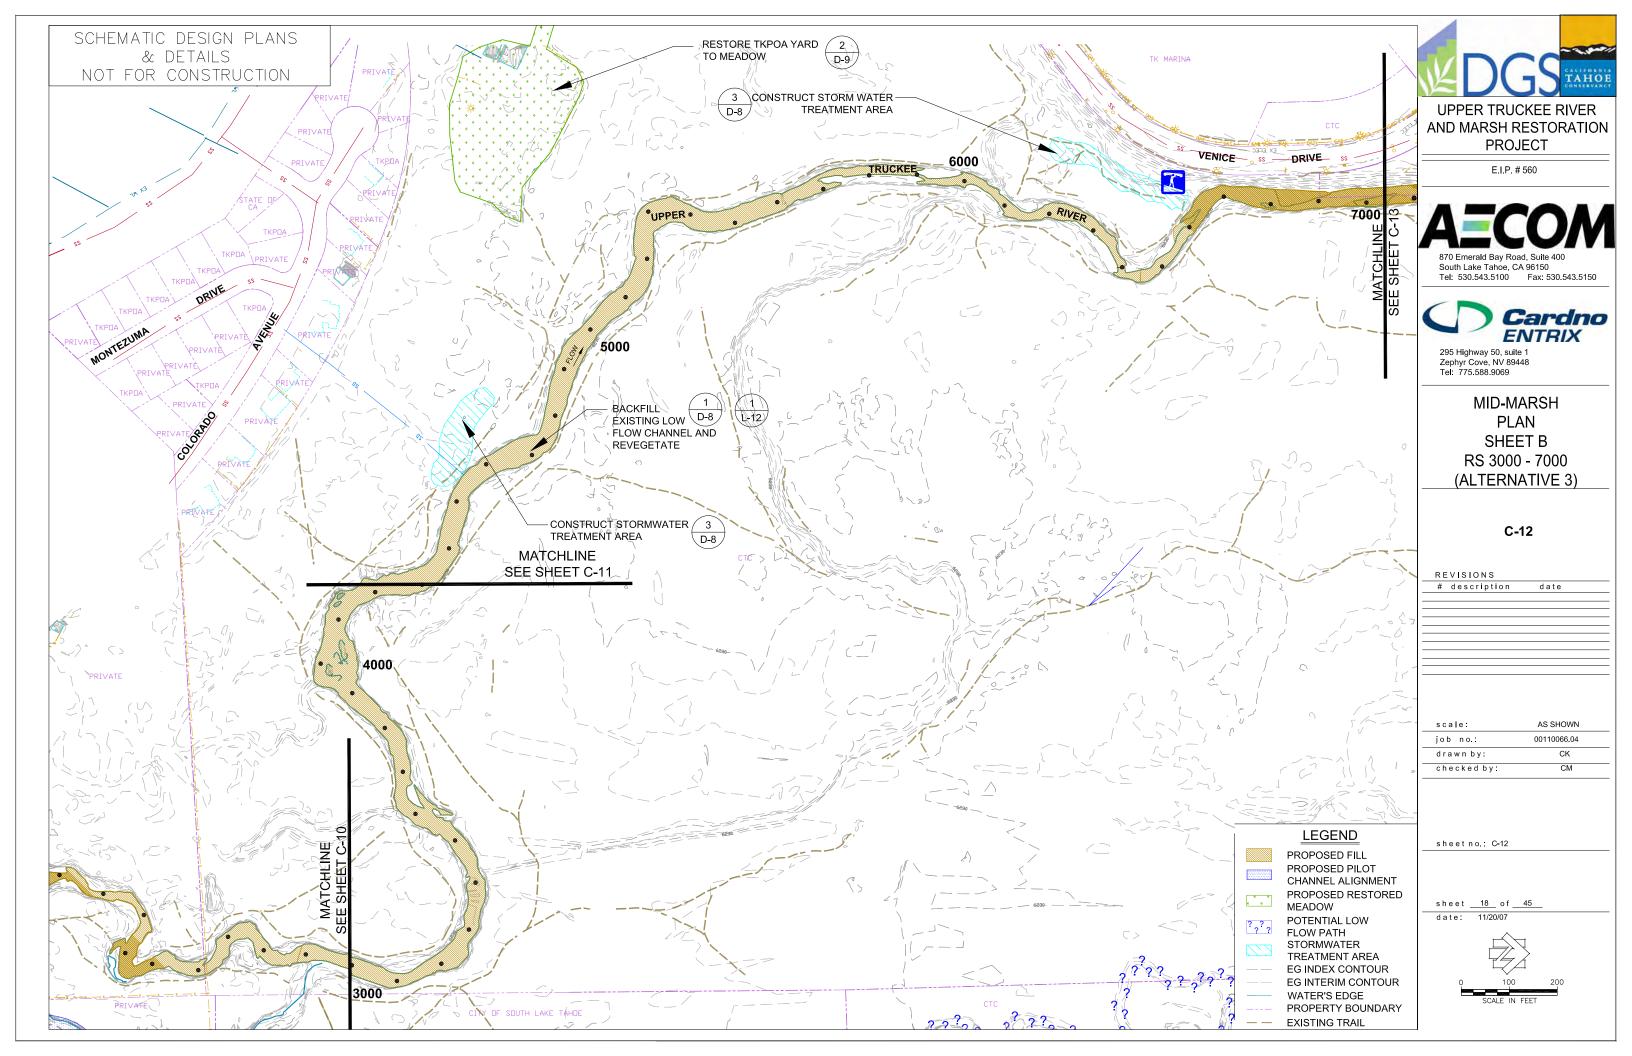
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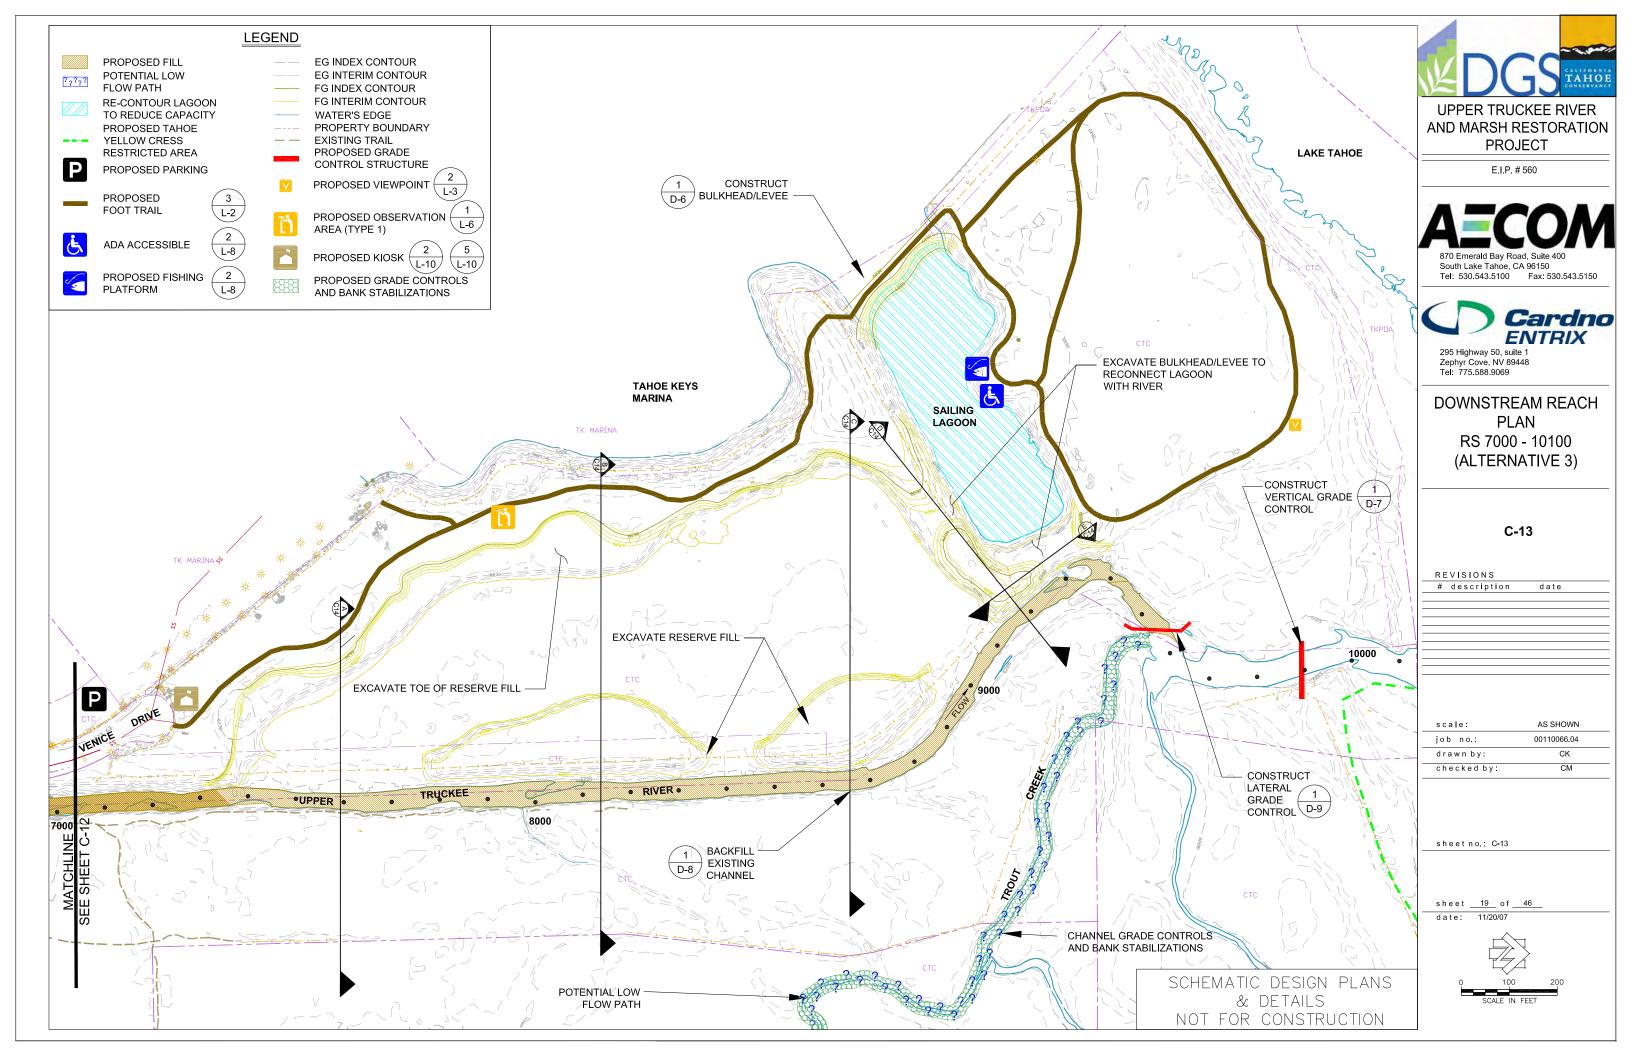



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DOWNSTREAM REACH RS 7000 - 10700 CROSS SECTIONS (ALTERNATIVE 3)

C-14

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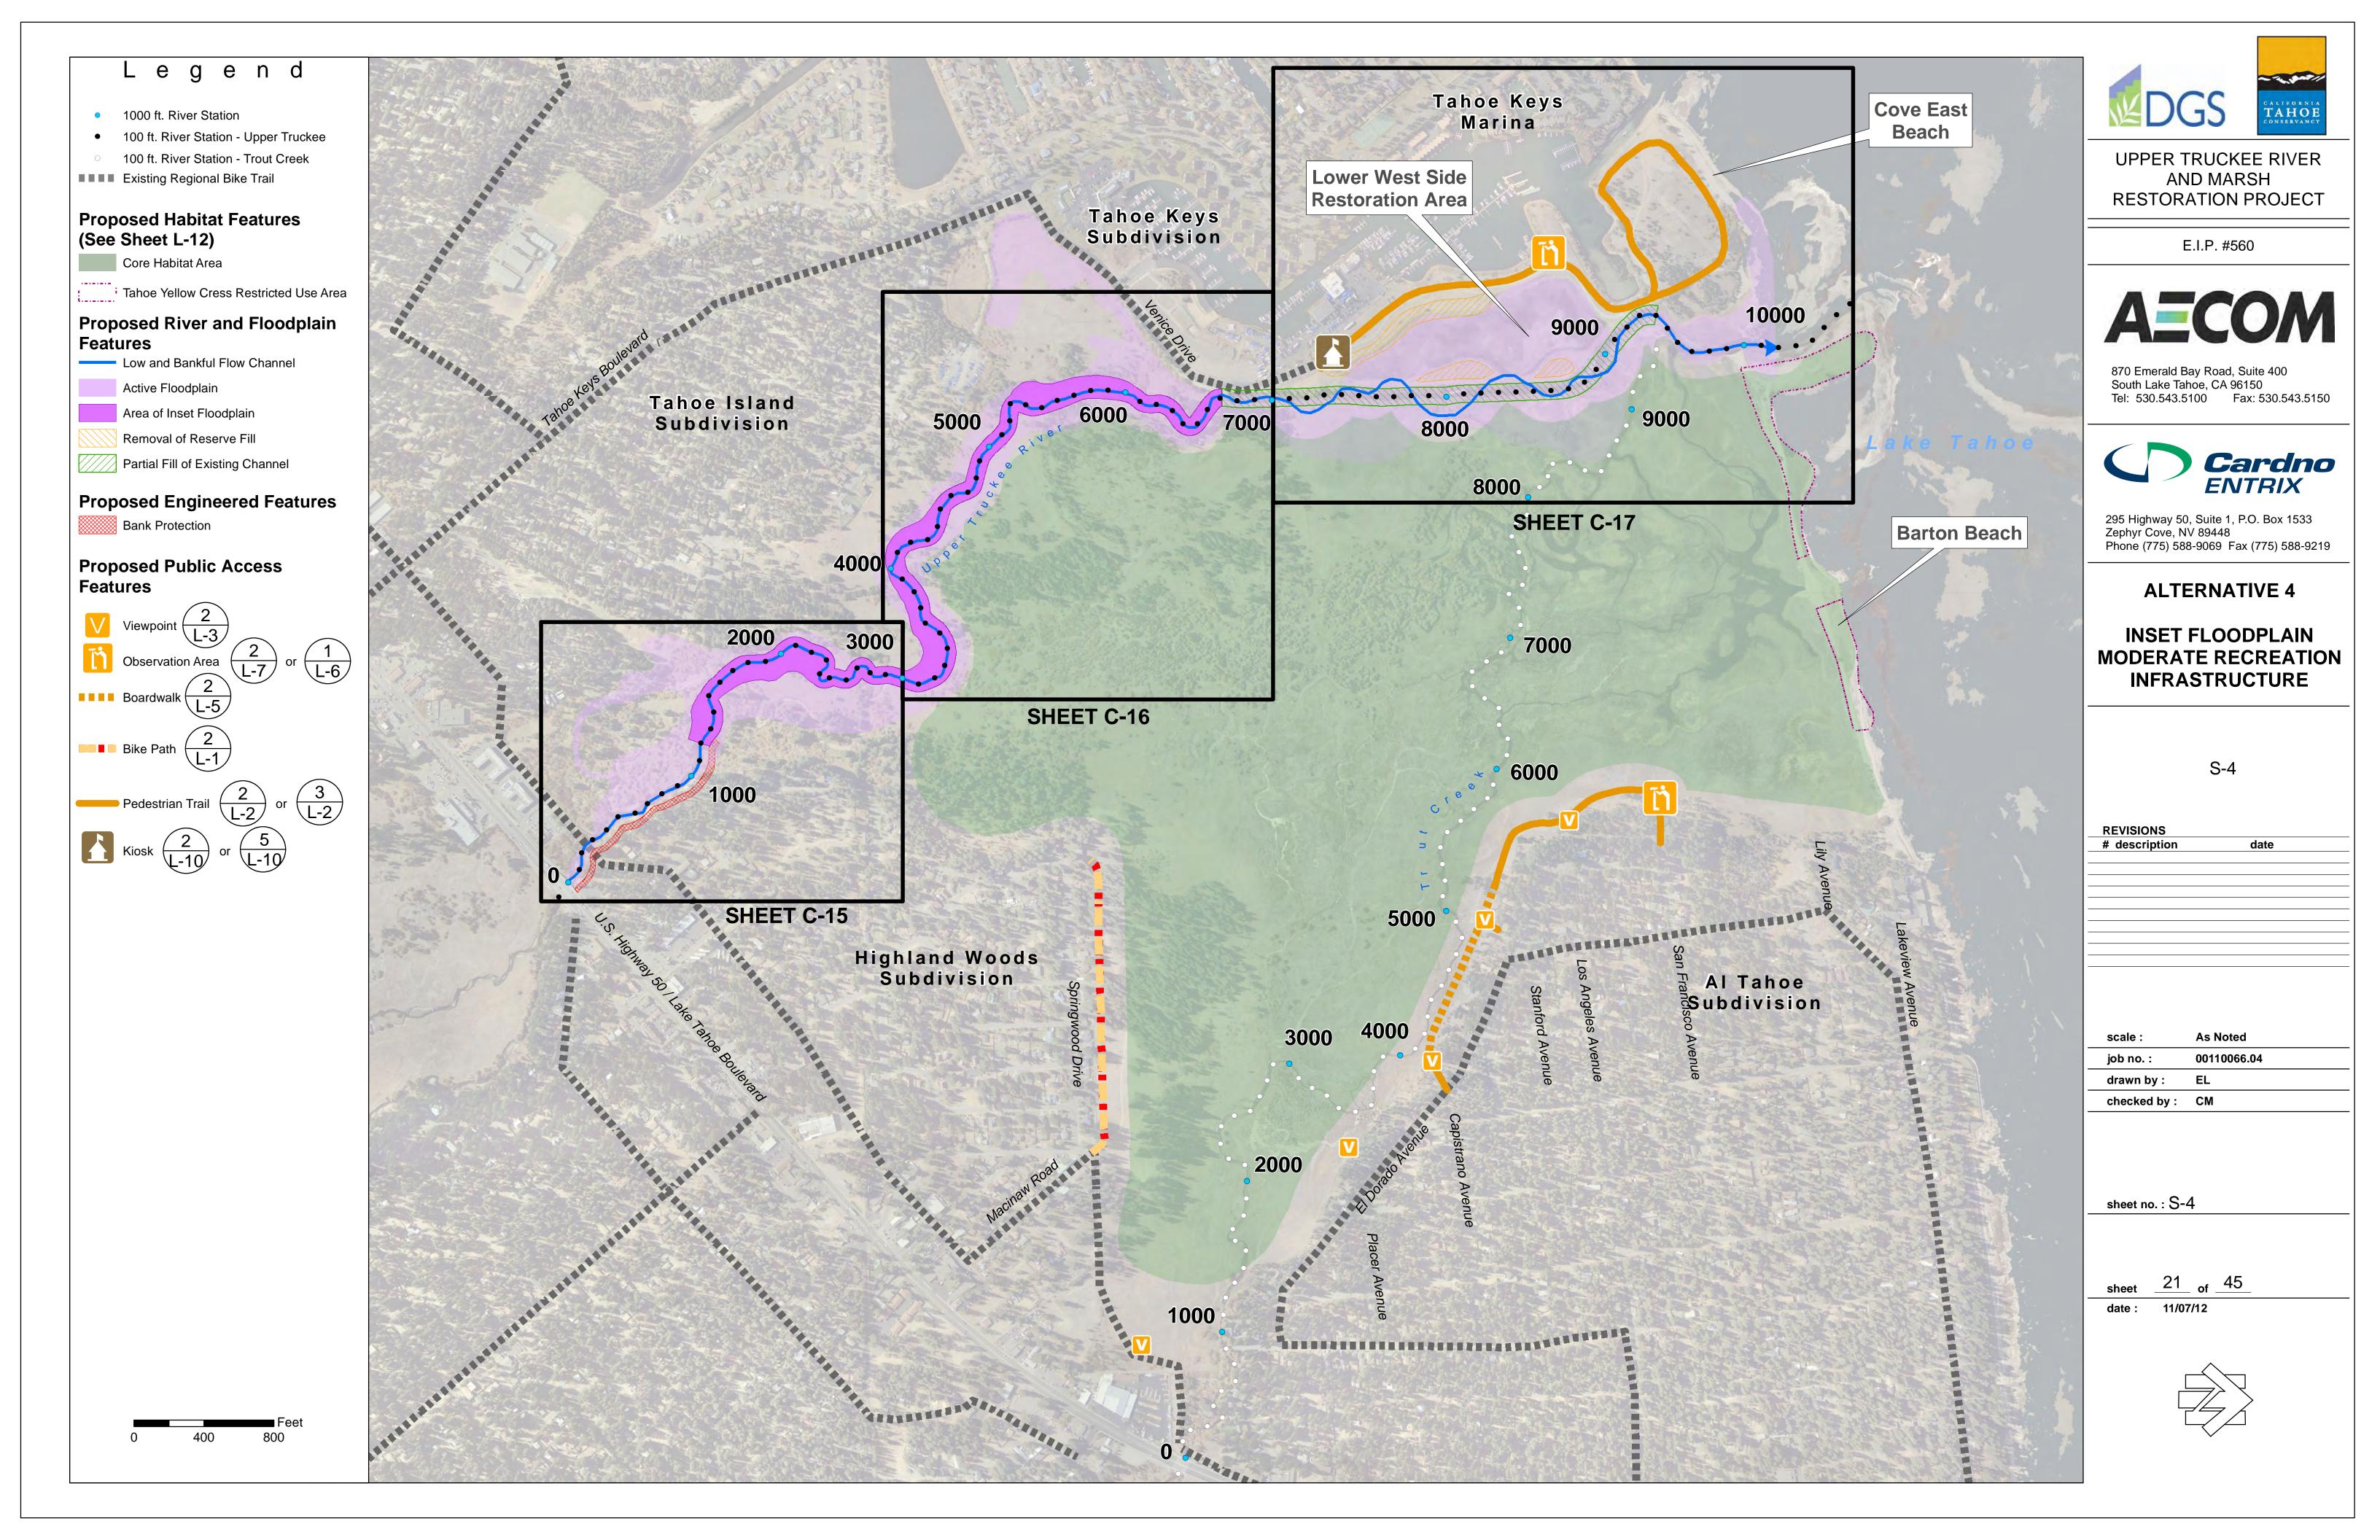
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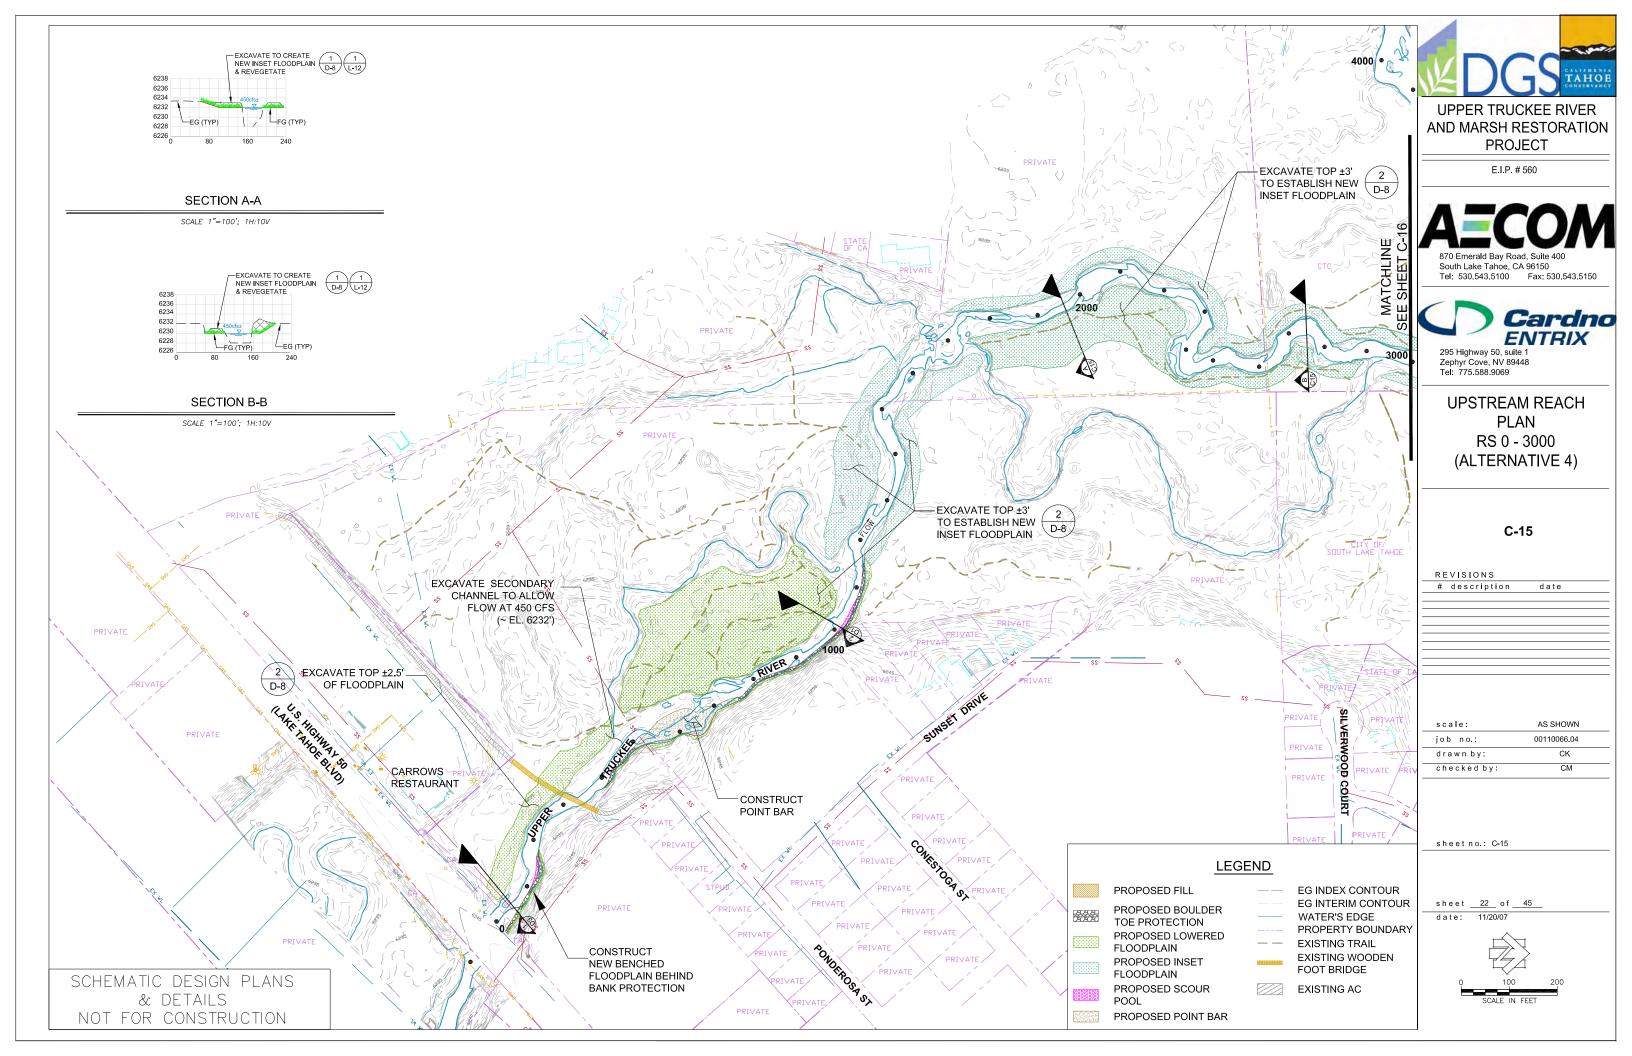
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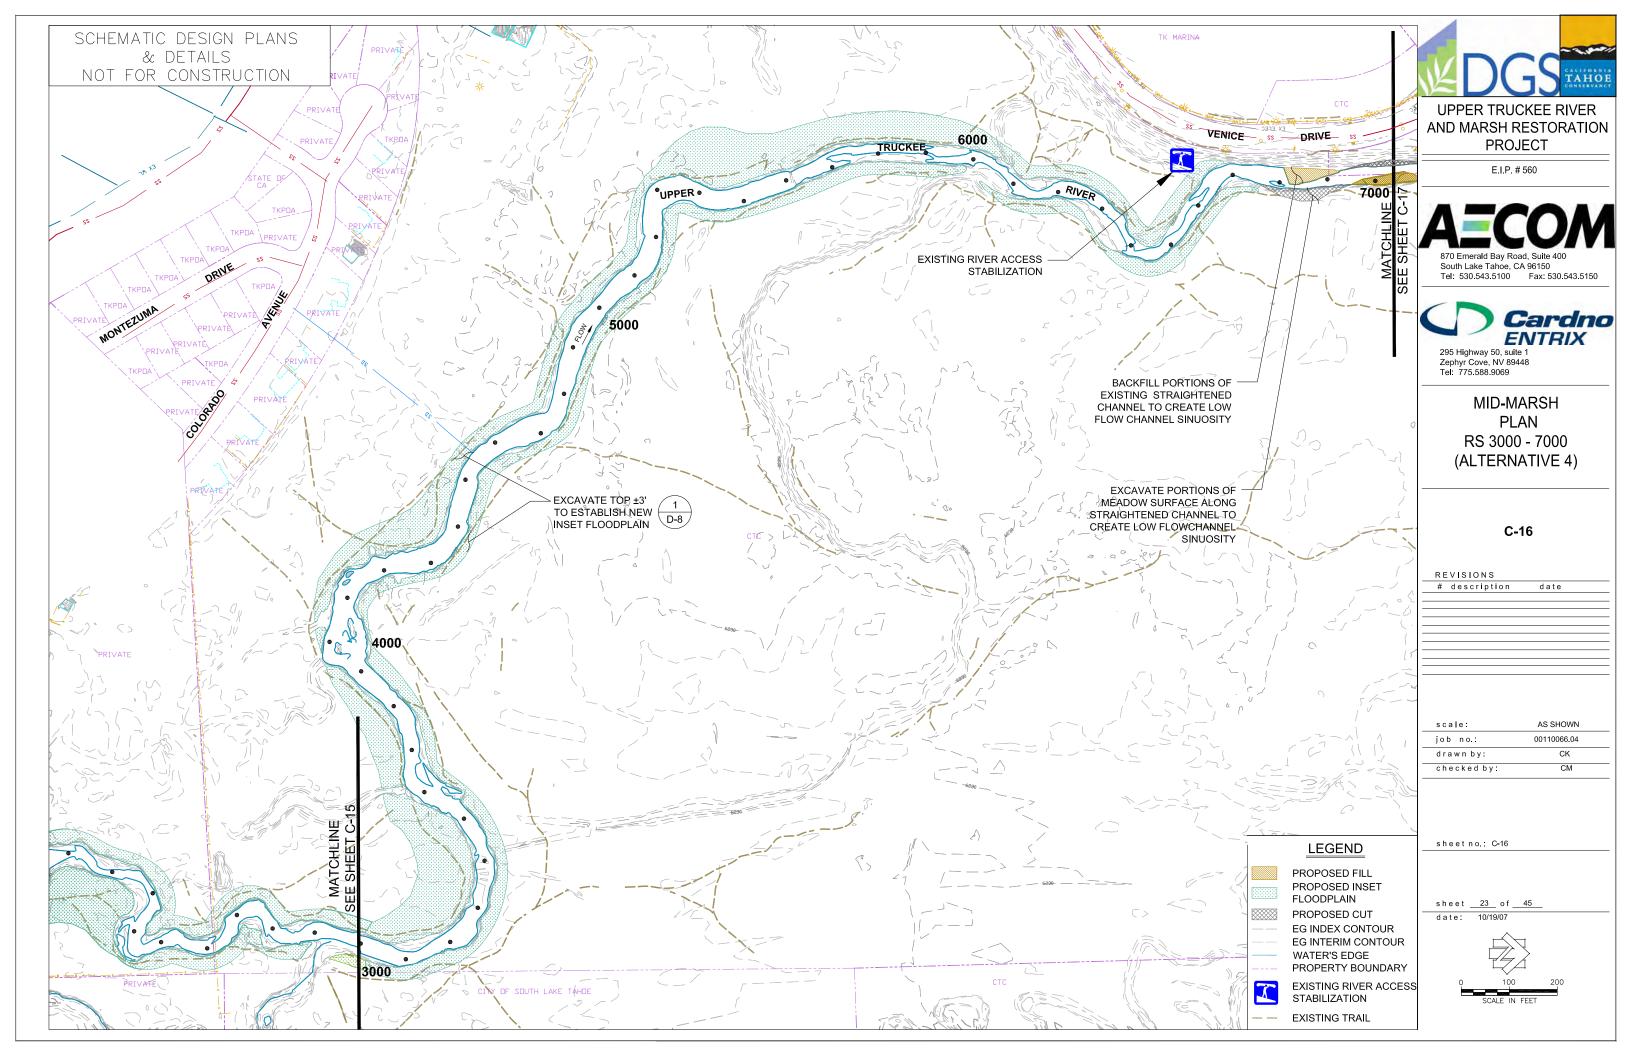
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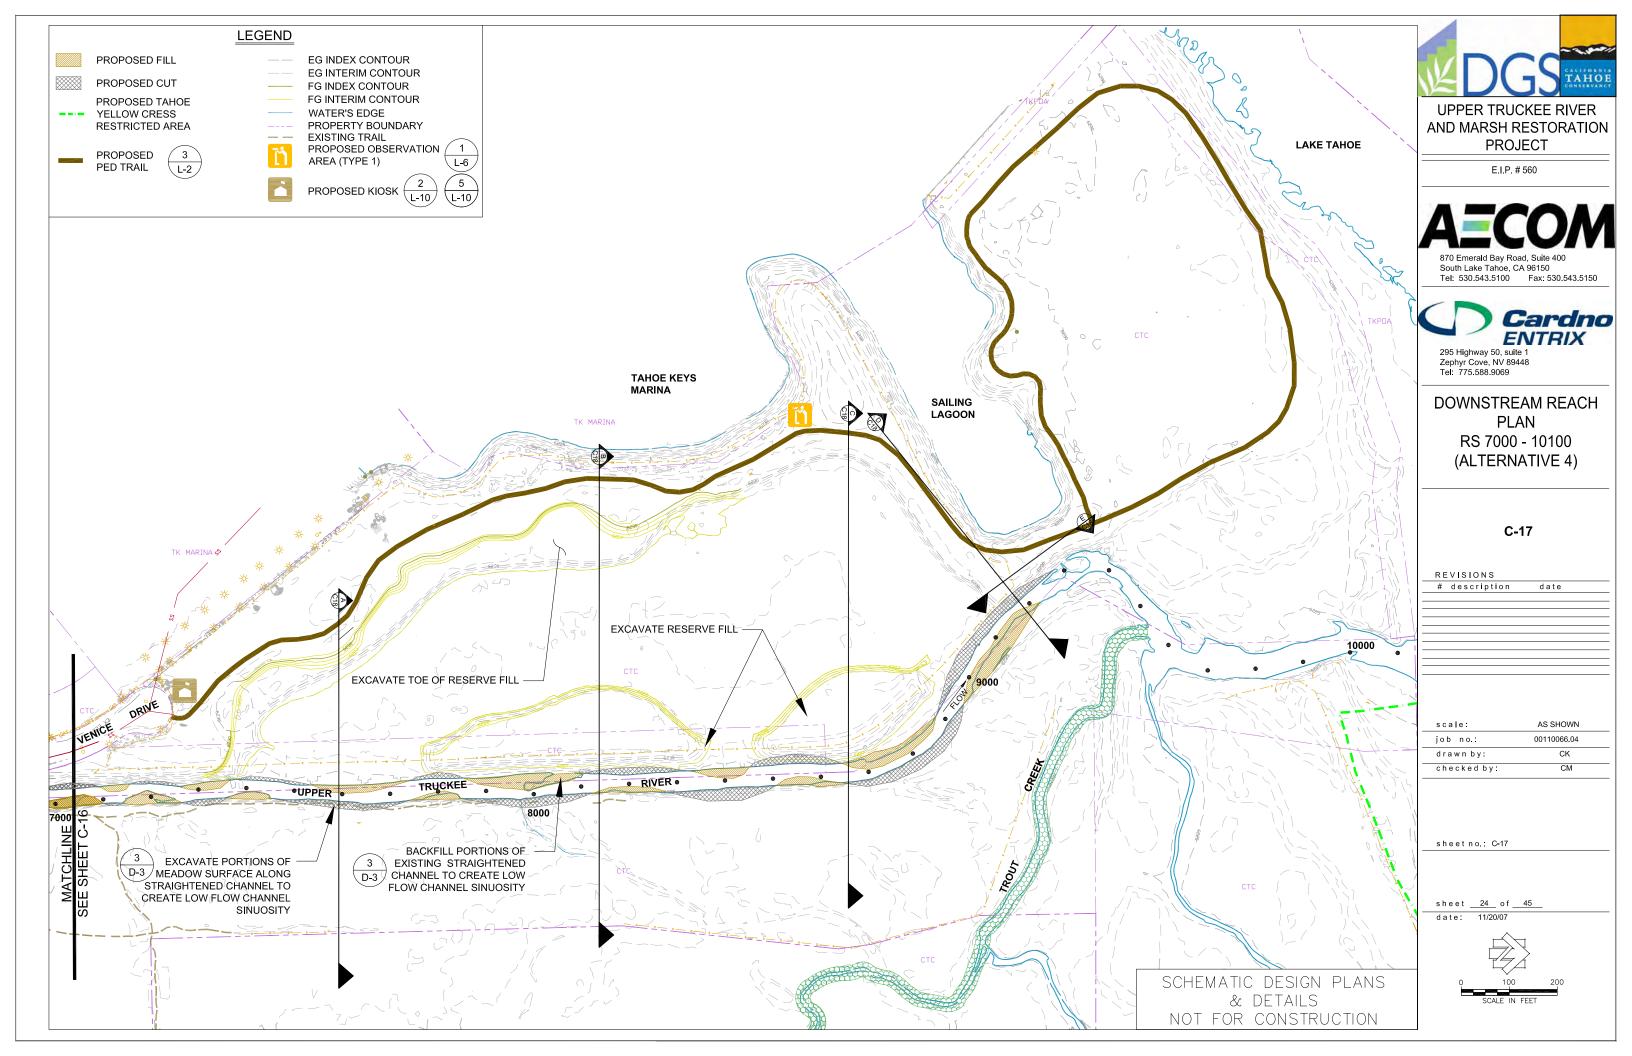
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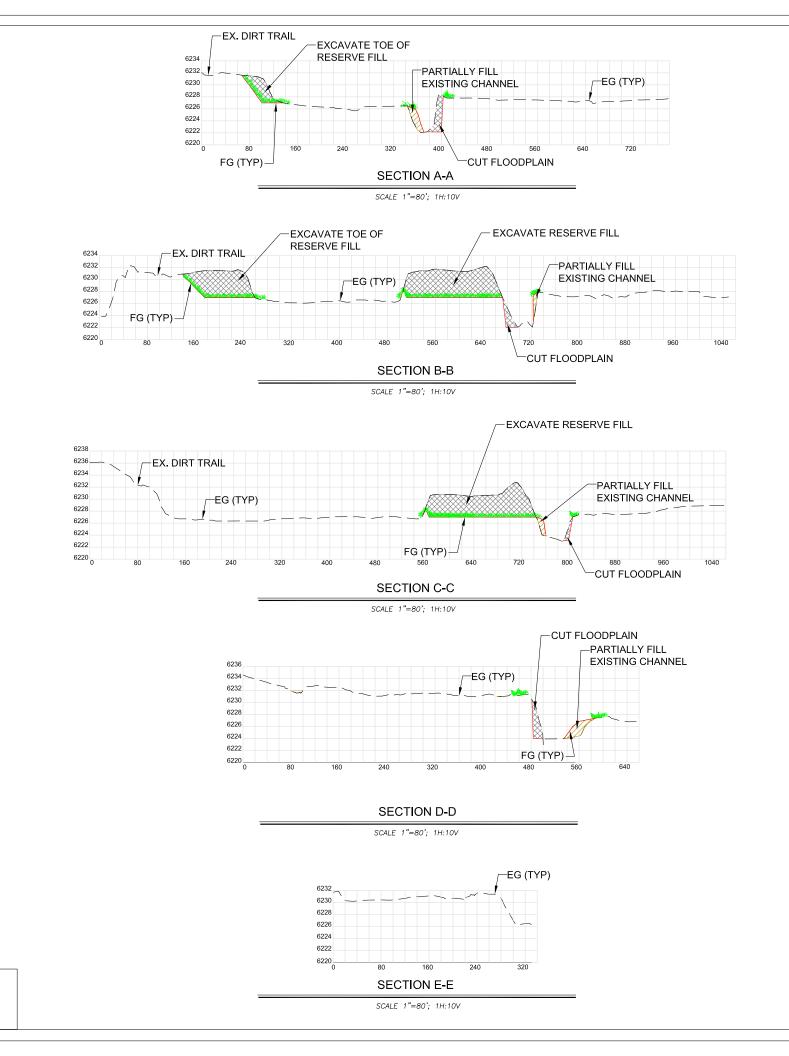




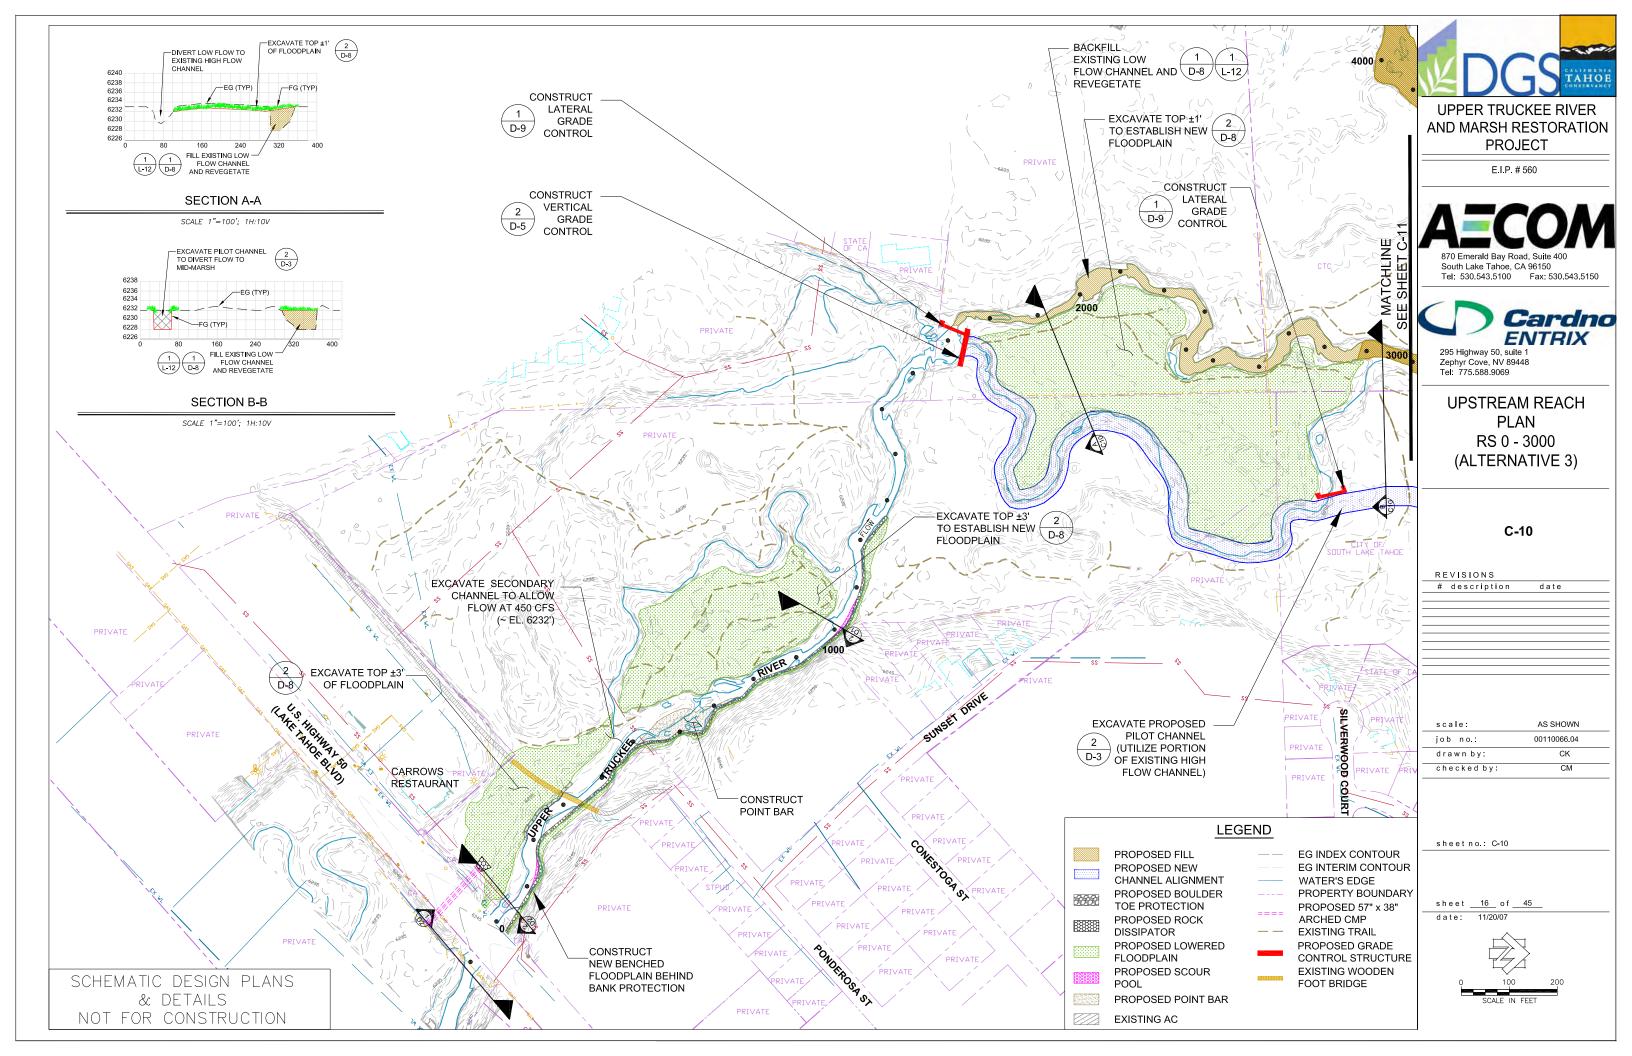

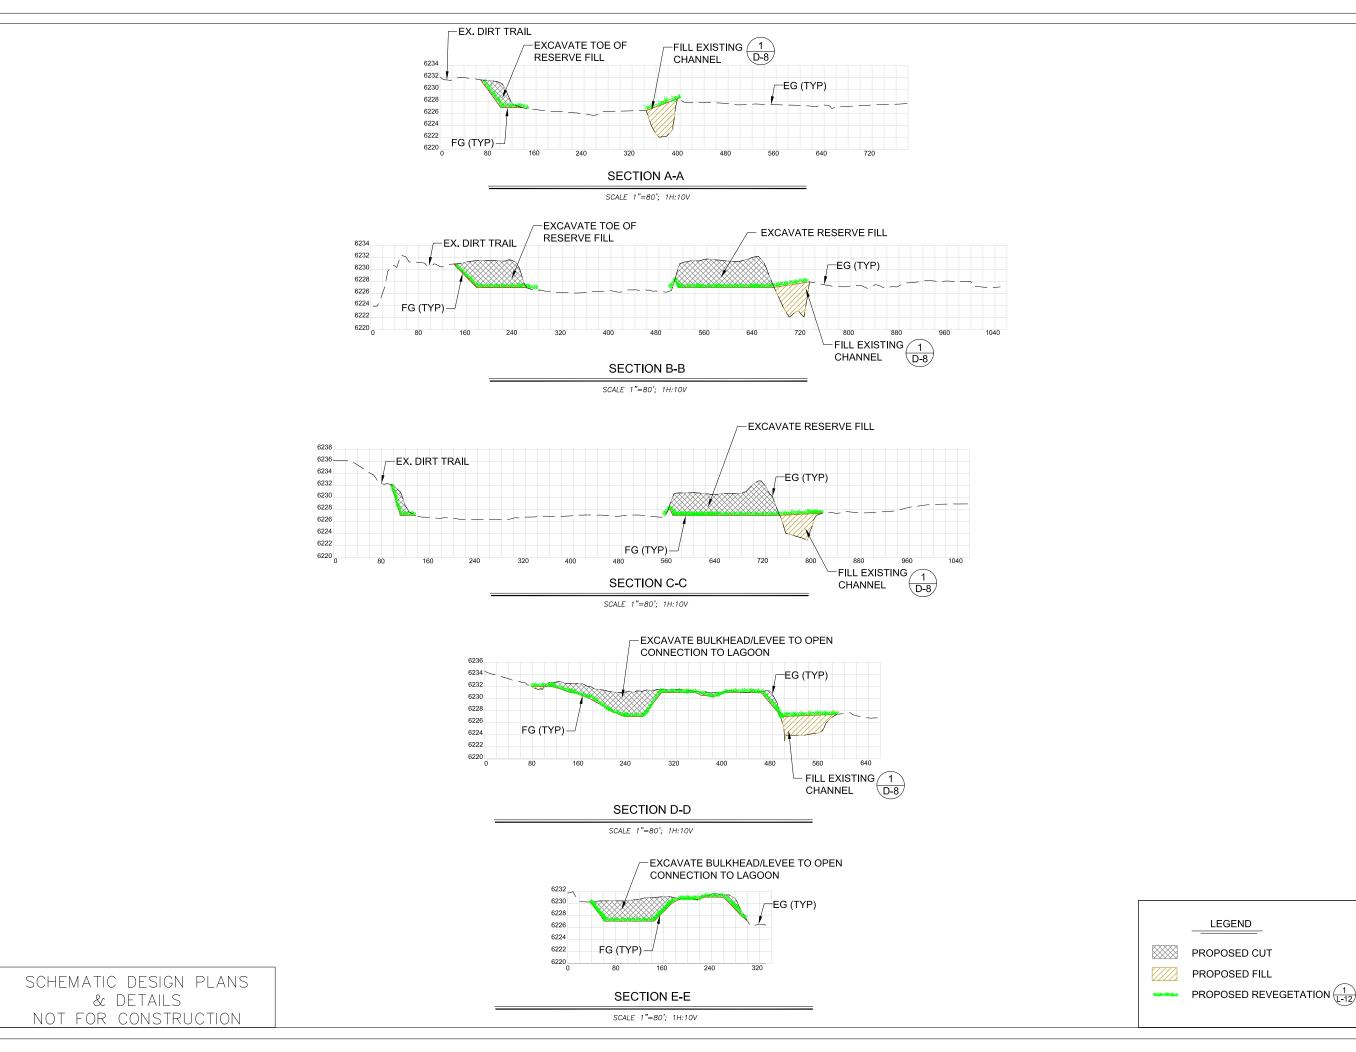





SCHEMATIC DESIGN PLANS

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DOWNSTREAM REACH RS 7000 - 10700 CROSS SECTIONS (ALTERNATIVE 4)

C-18

REVISIONS # description date

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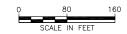
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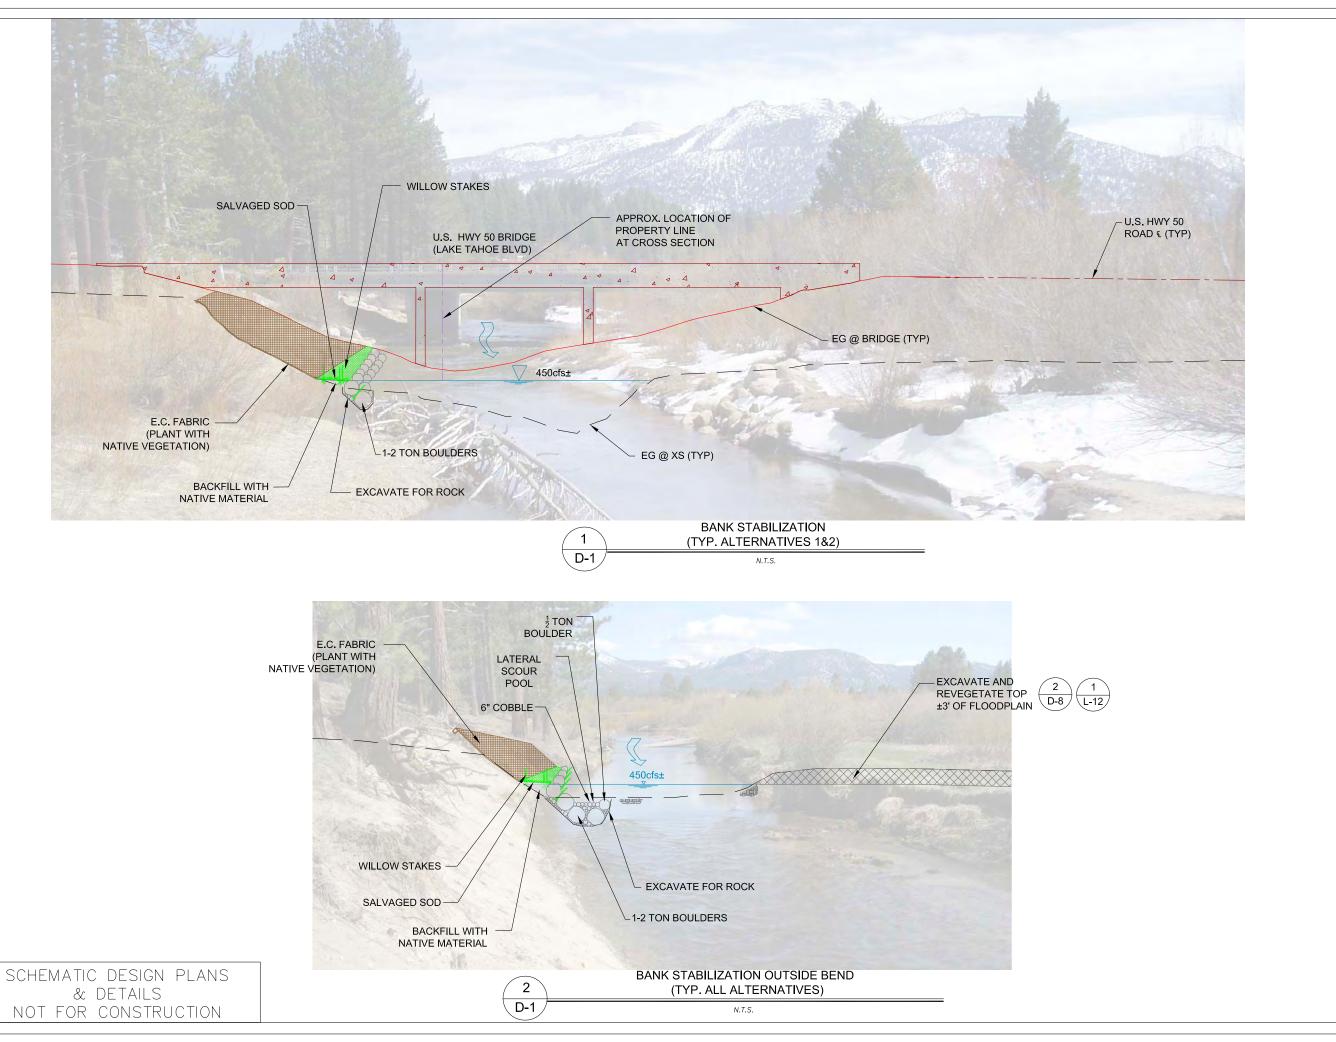
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LEGEND

PROPOSED CUT

PROPOSED REVEGETATION (1)







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DETAILS

D-1

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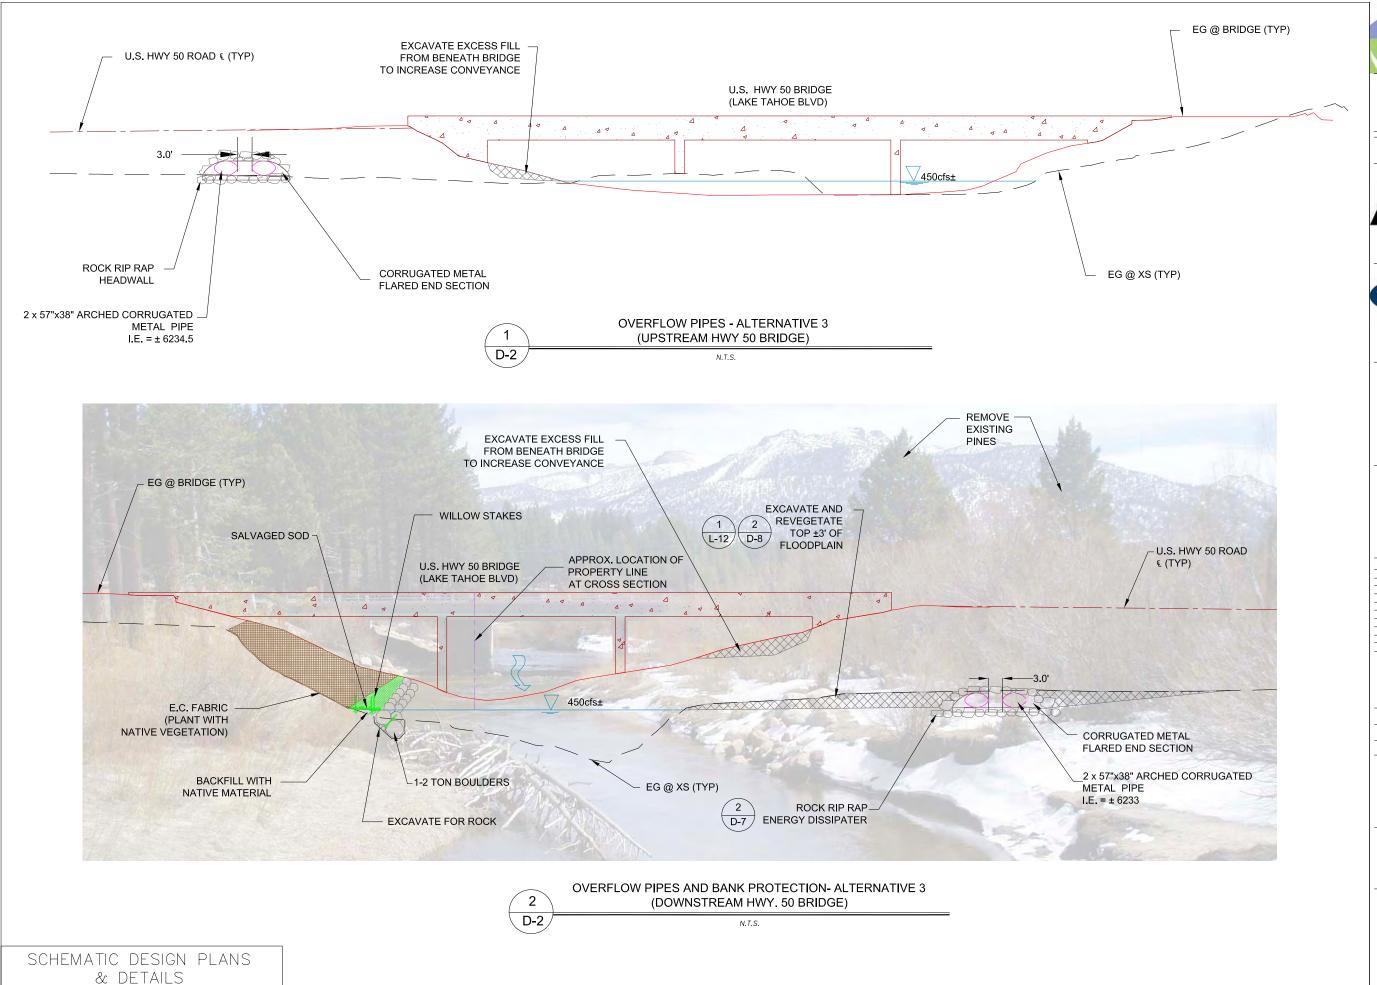
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sheet no.: D-1

sheet <u>26</u> of <u>45</u>



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DETAILS


D-2


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checked by:	CM

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sheet <u>27</u> of <u>45</u>



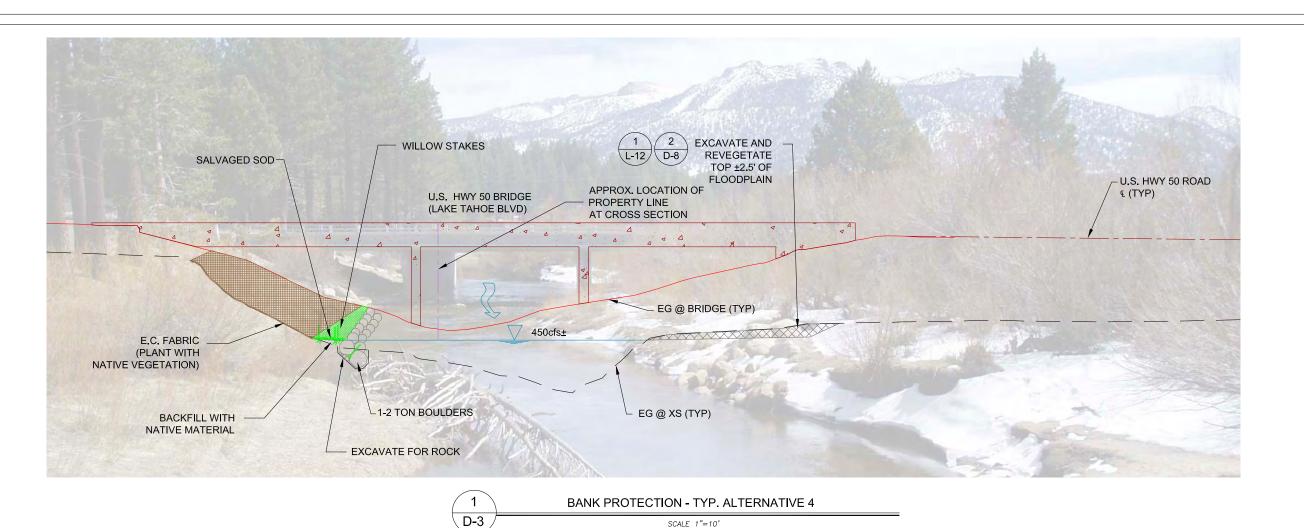

LINE **EXISTING** GRADE 4'± †YP. PLACE RIFFLE GRAVEL A MINIMUM SAND AND GRAVEL BLANKET 6" BEYOND END OF SOD BLANKET. GRAVEL TO BE AT LEAST

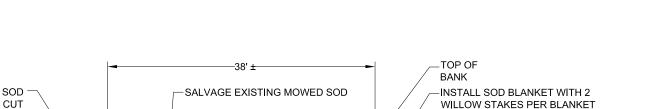NOTES:

1. TOP OF BANK LINE SHALL BE PAINTED PRIOR TO GRADING, BY THE ENGINEER.

3" THICK OVER END OF SOD.

PILOT CHANNEL TYP. CROSS-SECTION - ALTERNATIVE 3 2 D-3 NTS

TOP OF -38' ± **BANK** SOD 1 -SALVAGE EXISTING MOWED SOD -INSTALL SOD BLANKET WITH 2 CUT WILLOW STAKES PER BLANKET LINE **EXISTING** GRADE 4'± †YP. PLACE RIFFLE GRAVEL A MINIMUM SAND AND GRAVEL 6" BEYOND END OF SOD BLANKET. BLANKET GRAVEL TO BE AT LEAST 3" THICK OVER END OF SOD. NOTES:

1. TOP OF BANK LINE SHALL BE PAINTED PRIOR TO GRADING, BY THE ENGINEER.

MEADOW REACH TYPICAL CROSS -SECTION - ALTS 1, 2, & 4 D-3 NTS

SCHEMATIC DESIGN PLANS & DETAILS NOT FOR CONSTRUCTION

UPPER TRUCKEE RIVER AND MARSH RESTORATION **PROJECT**

E.I.P. # 560

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DETAILS

D-3


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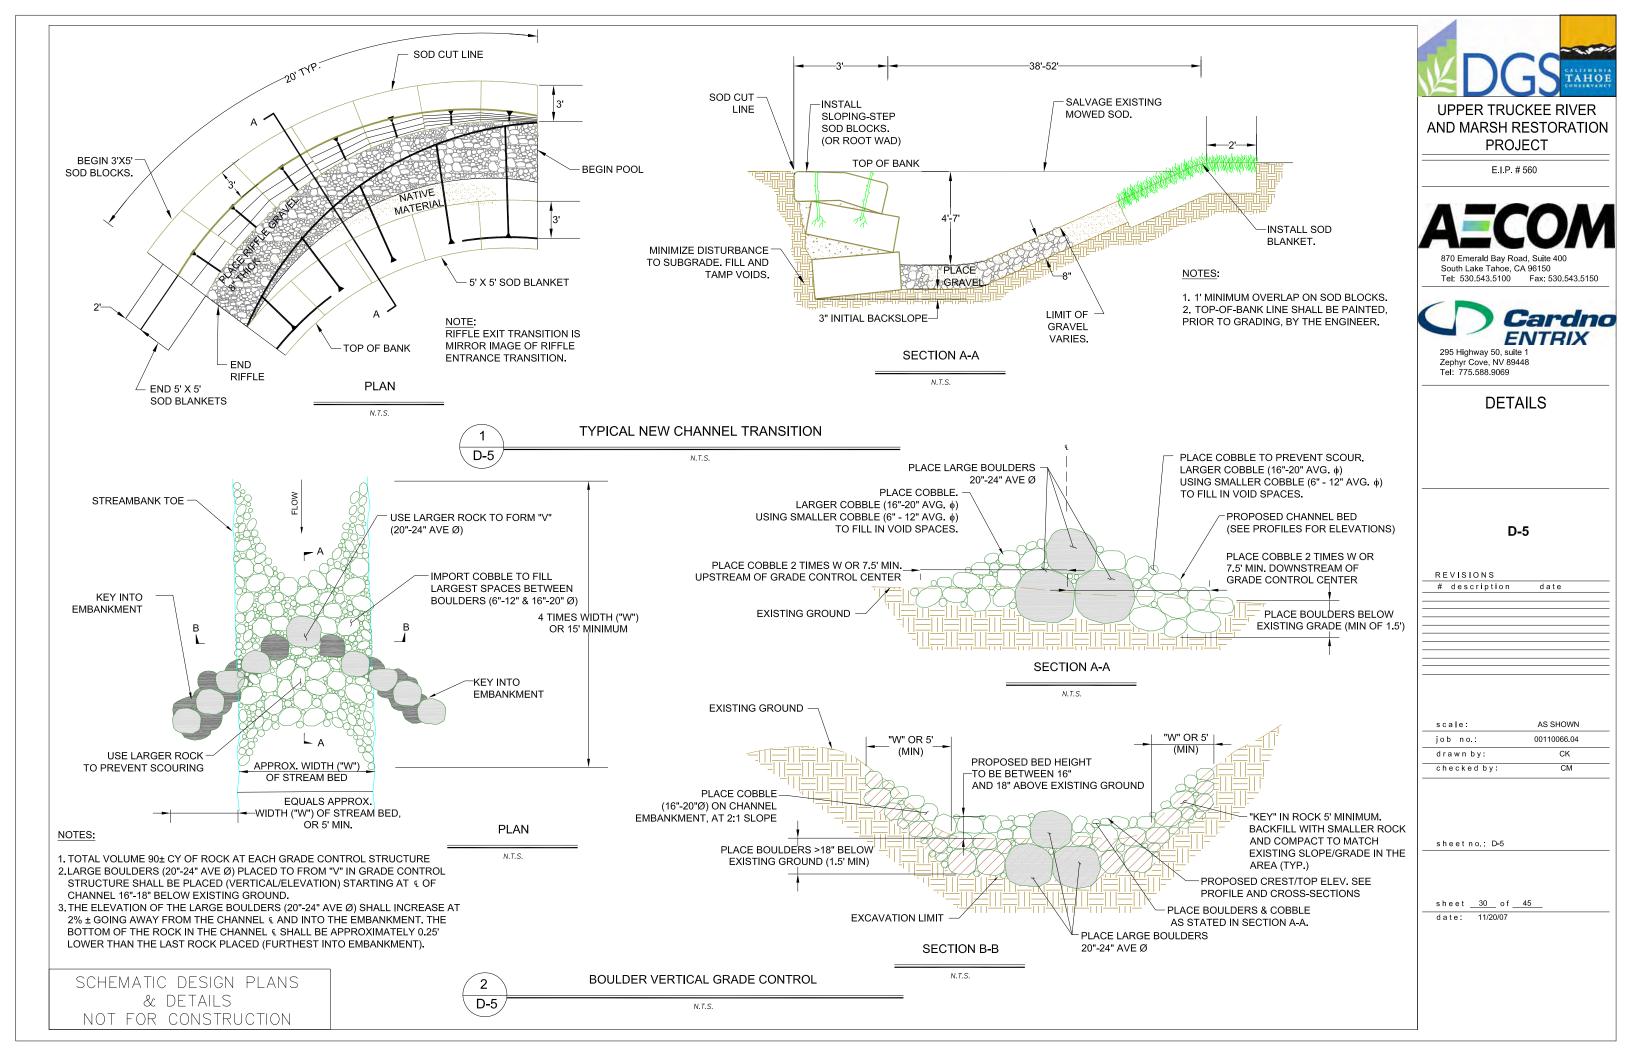
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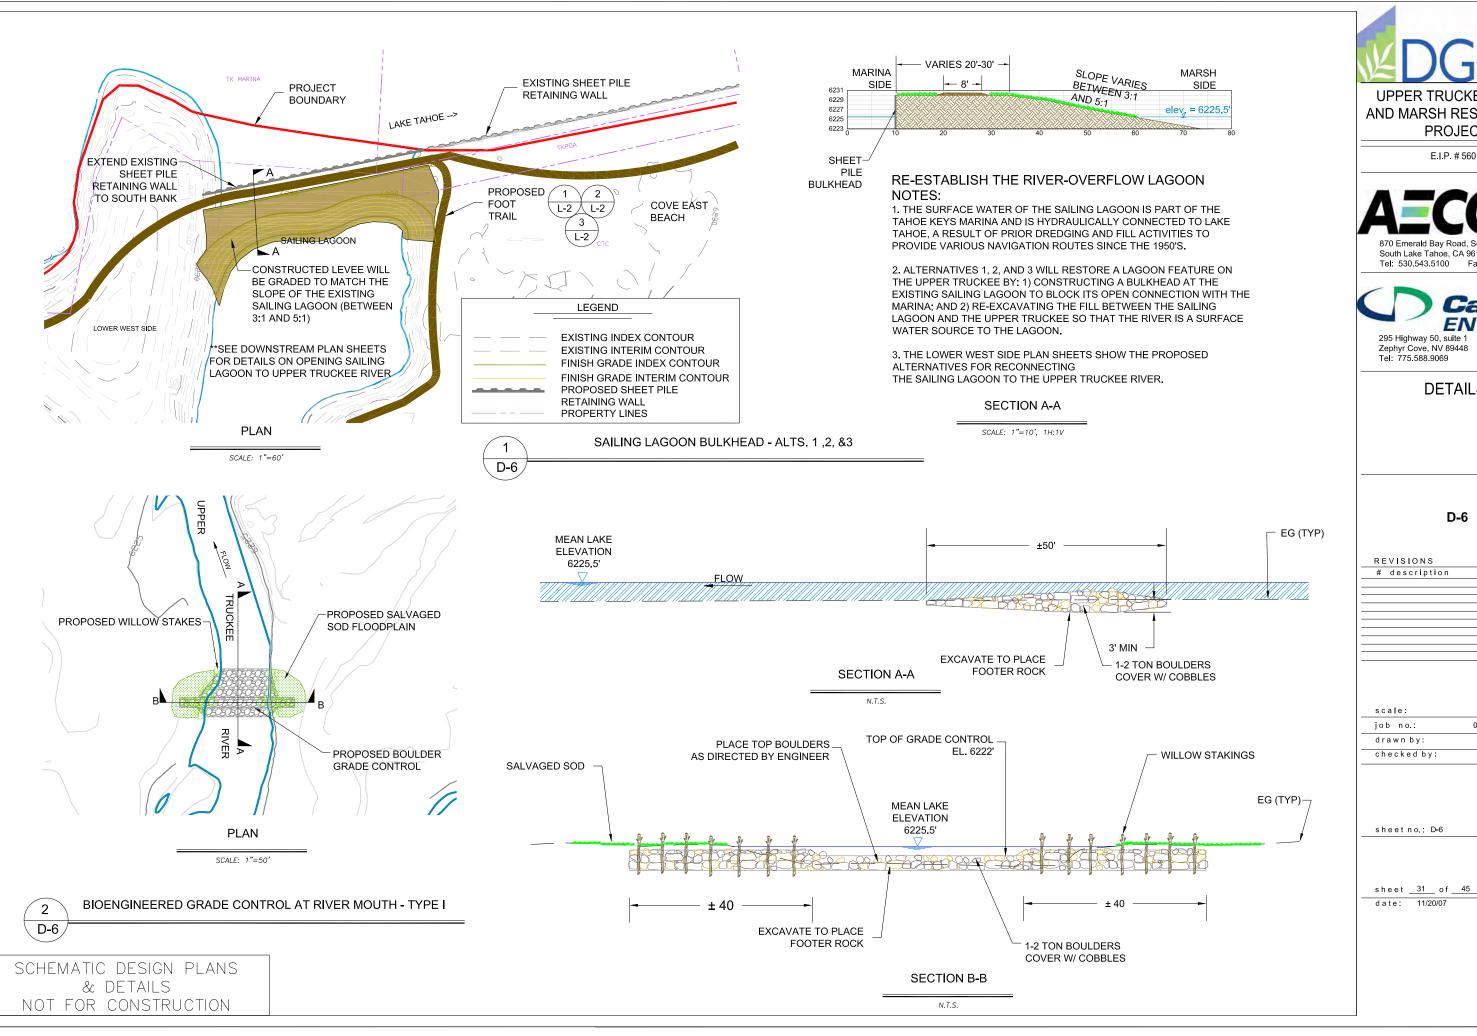
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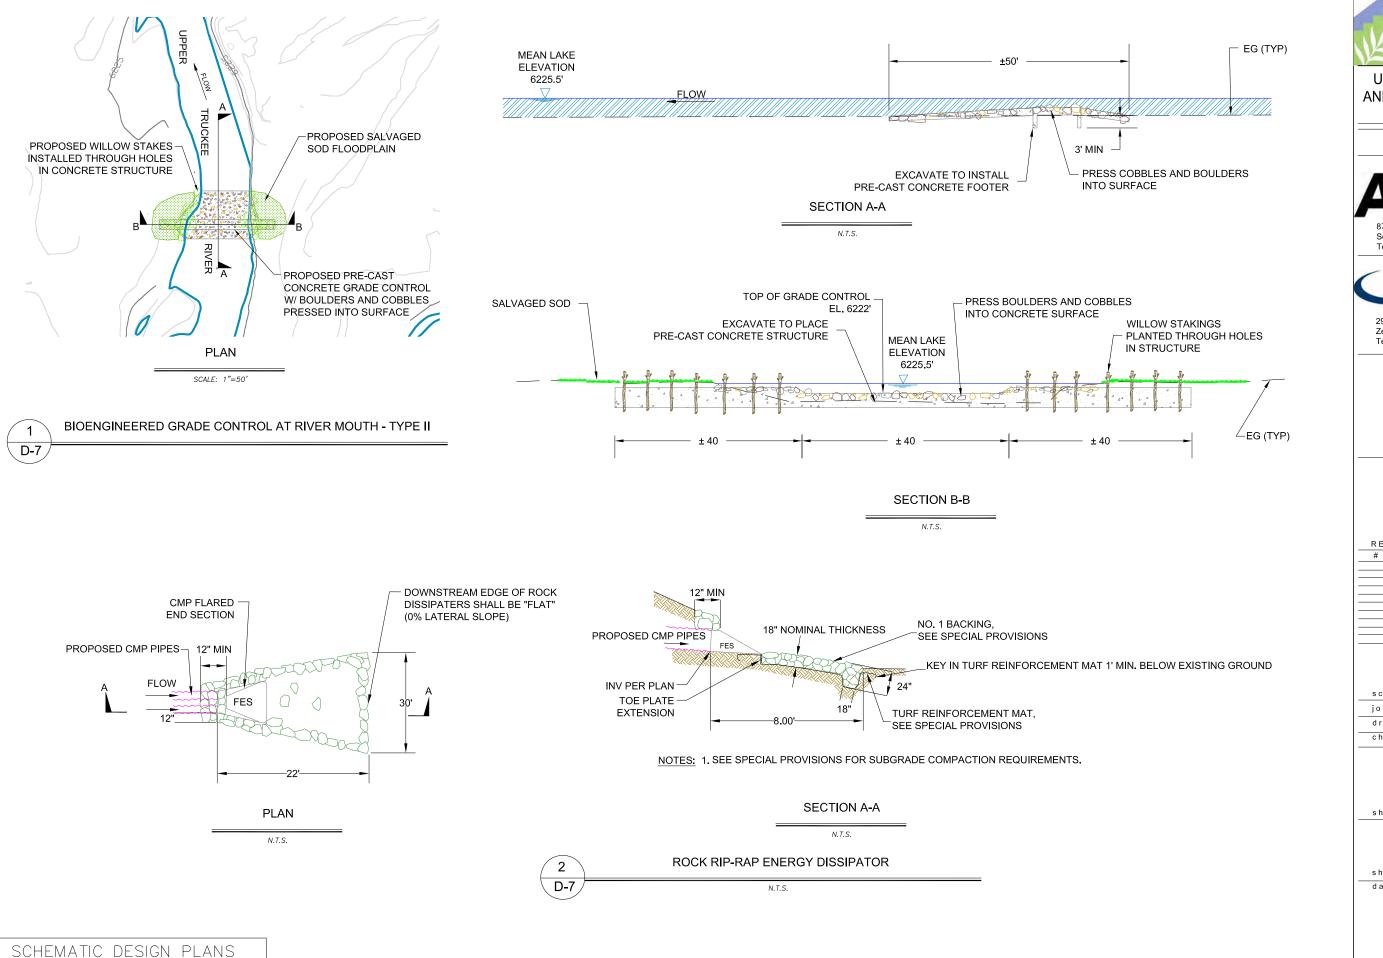
Zephyr Cove, NV 89448 Tel: 775.588.9069

DETAILS

D-6

description date

AS SHOWN 00110066.04 СК CM

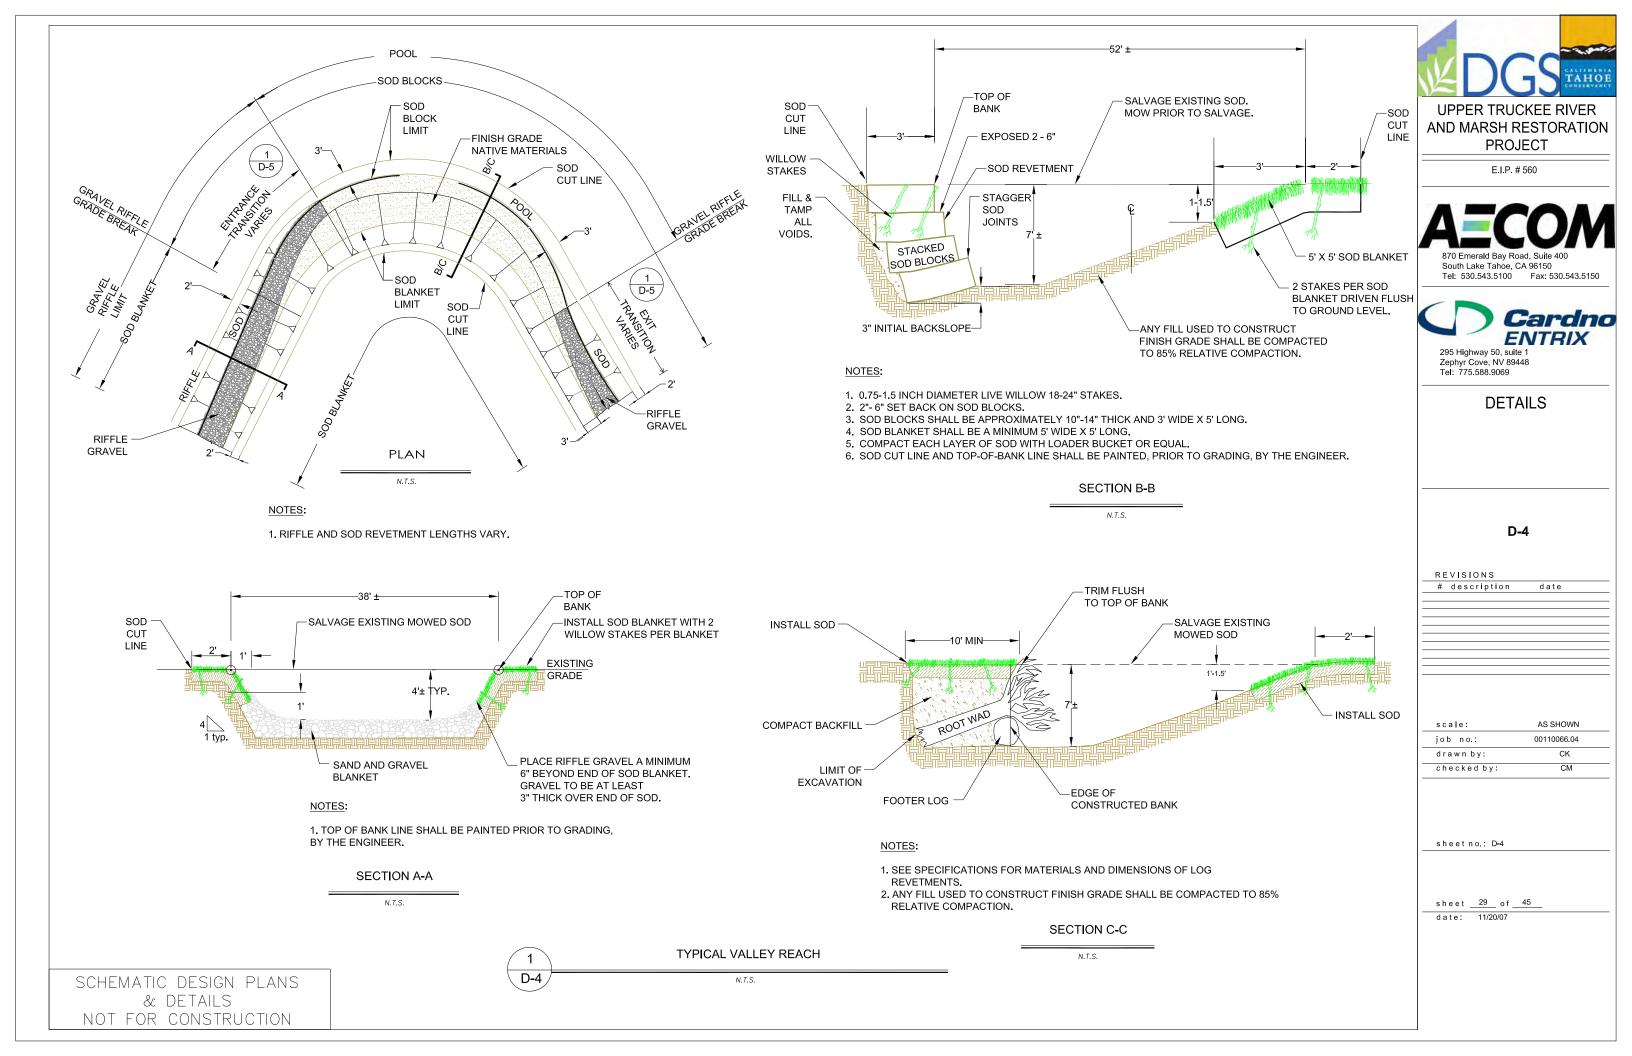

& DETAILS NOT FOR CONSTRUCTION

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295 Highway 50, suite 1 Zephyr Cove, NV 89448 Tel: 775.588.9069

DETAILS


D-7

REVISIONS # description date

scale: AS SHOWN job no: 00110066.04 drawn by: CK checked by: CM

sheet no.: D-7

sheet <u>32</u> of <u>45</u> date: 11/20/07

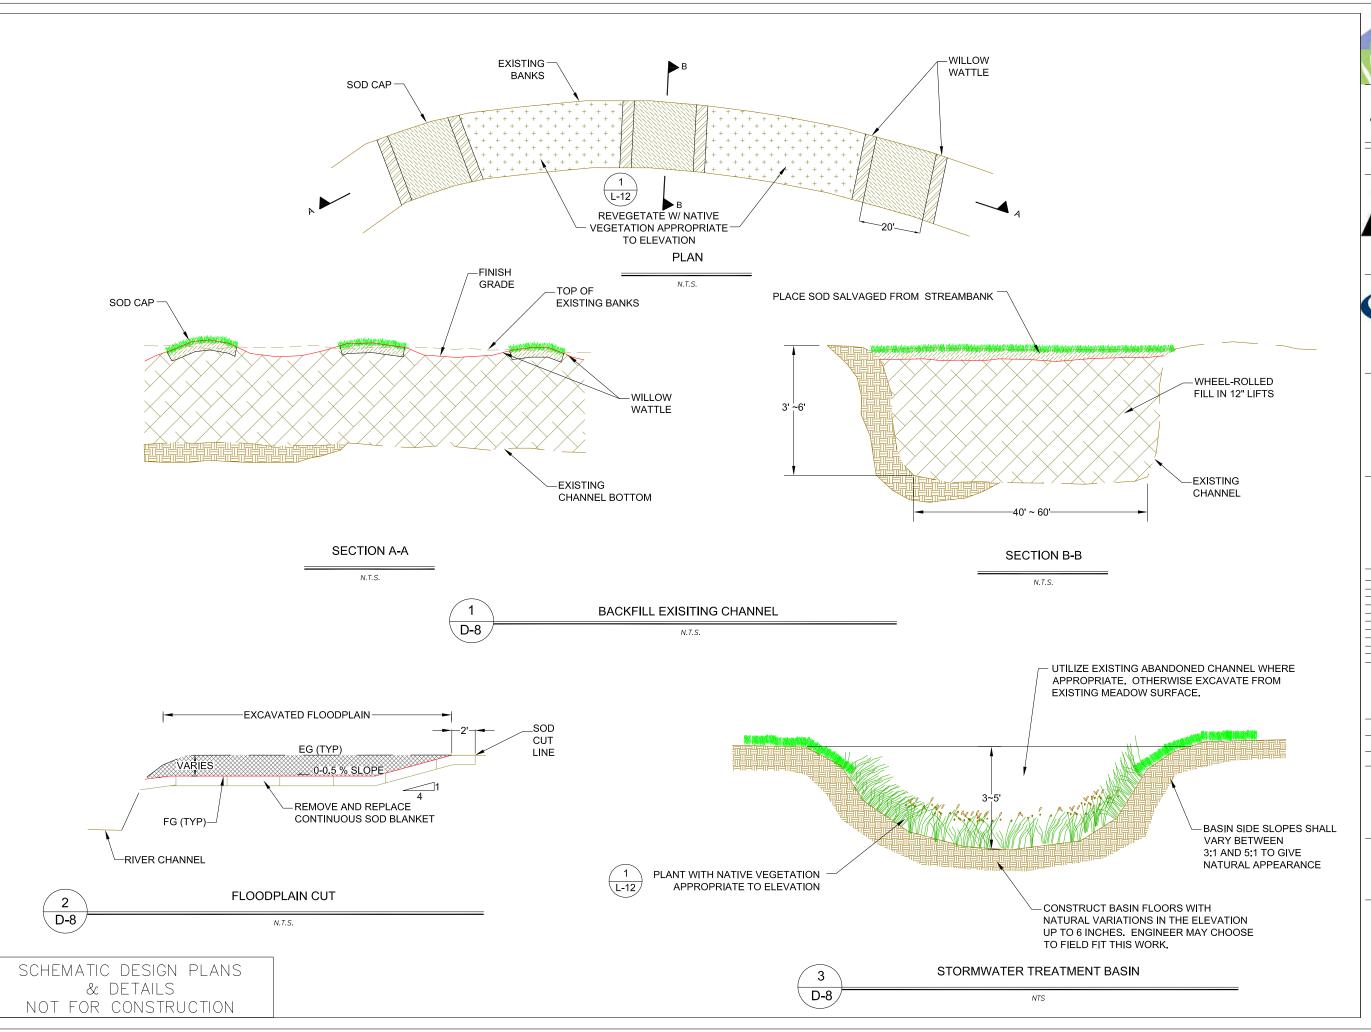



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DETAILS

D-8

REVISIONS

description date

scale: AS SHOWN


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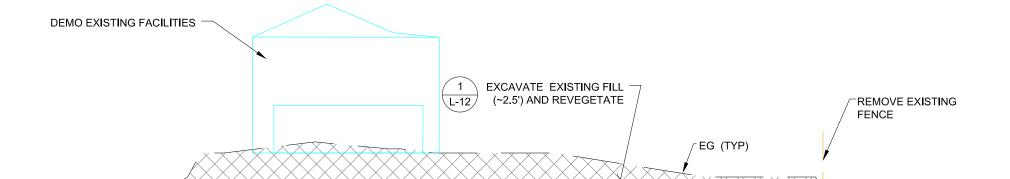
drawn by: CK

checked by: CM

sheet no.: D-8

sheet <u>33</u> of <u>45</u>



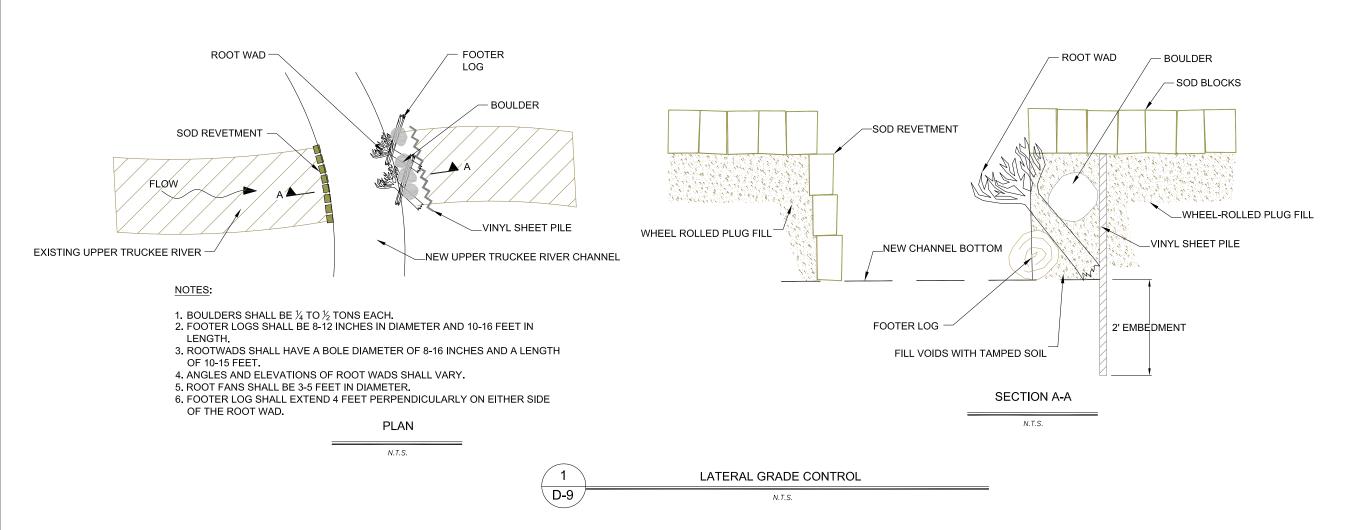

TKPOA YARD RESTORATION

D-9

SCHEMATIC DESIGN PLANS & DETAILS NOT FOR CONSTRUCTION TKPOA YARD RESTORATION

N.T.S.



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DETAILS

D-9

REVISIONS
description date

scale: AS SHOWN

job no.: 00110066.04

drawn by: CK

checked by: CM

sheet no.: D-9

sheet 34 of 45 date: 11/20/07 2-FOOT-WIDE

SHOULDER-

L-1 SCALE: NTS

NOTES:

8' OR 10' D.G./A.C. BIKE TRAIL

MIN. = MINIMUM RECREATION INFRASTRUCTURE

MOD. = MODERATE RECREATION INFRASTRUCTURE

SHOULDER

ELEVATION

MAX. = MAXIMUM RECREATION INFRASTRUCTURE

NOTE: WHERE TITLED "BIKE TRAIL" SHALL MEAN THE SAME AS "BIKE PATH".

UPPER TRUCKEE RIVER AND MARSH RESTORATION **PROJECT**

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BIKE TRAIL

L-1

REVISIONS # description

NOT TO SCALE scale: 00110066.04 job no.: drawn by: ML

sheet no.: L-1

checked by:

sheet <u>35</u> of <u>45</u> date: 05/02/12


2-FOOT-WIDE SHOULDER-10-FOOT-WIDE A.C. BIKE TRAIL-

A.C. BIKE TRAIL (MAX.) L-1 SCALE: NTS **PLAN VIEW**

L-1 SCALE: NTS

2-FOOT-WIDE SHOULDER

D.G./A.C. BIKE TRAIL (MIN./MOD./MAX.)

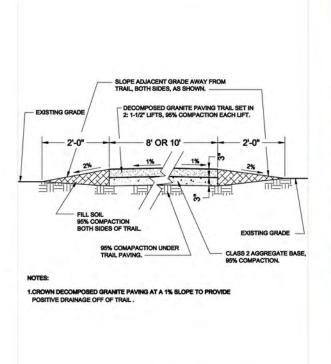

D.G. BIKE TRAIL (MIN./MOD.)

D.G. BIKE TRAIL (MIN./MOD.) L-1 | SCALE: NTS SECTION




8-FOOT-WIDE (MIN.) 10-FOOT-WIDE (MOD.)

PLAN VIEW

D.G. BIKE TRAIL

D.G. BIKE TRAIL (MIN./MOD.) L-1 | SCALE: NTS REPRESENTATIVE **EXAMPLE**

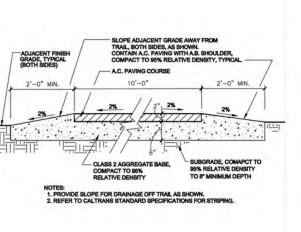

A.C. BIKE TRAIL (MAX.) L-1 | SCALE: NTS SECTION



7 A.C. BIKE TRAIL (MAX.) L-1 SCALE: NTS REPRESENTATIVE **EXAMPLE**

6-FOOT-WIDE


D.G. FOOT TRAIL -

MIN. = MINIMUM RECREATION INFRASTRUCTURE

MOD. = MODERATE RECREATION INFRASTRUCTURE

MAX. = MAXIMUM RECREATION INFRASTRUCTURE

PLAN VIEW

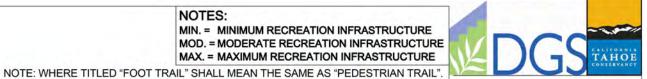

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FOOT TRAIL

L-2

REVISIONS # description date

NOT TO SCALE scale: 00110066.04 job no.: drawn by: ML checked by:

sheet no.: L-2

sheet <u>36</u> of <u>45</u> date: 05/02/12

4-FOOT-WIDE D.G. FOOT TRAIL

FOOT TRAIL (MOD.) L-2 SCALE: NTS **PLAN VIEW**

3 L-2

FOOT TRAIL (MAX.) SCALE: NTS

FOOT TRAIL (MIN.) L-2 SCALE: NTS REPRESENTATIVE EXAMPLE



FOOT TRAIL (MOD./MAX.) L-2 SCALE: NTS

4' OR 6' FILL SOIL 95% COMPACTION BOTH SIDES OF TRAIL 95% COMAPACTION UNDER TRAIL PAVING. CLASS 2 AGGREGATE BASE, 95% COMPACTION. 1.CROWN DECOMPOSED GRANITE PAVING AT A 1% SLOPE TO PROVIDE POSITIVE DRAINAGE OFF OF TRAIL.

DECOMPOSED GRANITE PAVING TRAIL SET IN 2: 1-1/2" LIFTS, 95% COMPACTION EACH LIFT.

FOOT TRAIL (MIN.)

SCALE: NTS

L-2

EXISTING GRADE

4-FOOT-WIDE

FOOT TRAIL (MAX.) L-2 SCALE: NTS

SECTION

PLAN VIEW

REPRESENTATIVE EXAMPLE

D.G. BIKE TRAIL

VIEW POINT (MIN.)

L-3 SCALE: NTS

NOTES:

MIN. = MINIMUM RECREATION INFRASTRUCTURE

MOD. = MODERATE RECREATION INFRASTRUCTURE

MAX. = MAXIMUM RECREATION INFRASTRUCTURE

PLAN VIEW

ELEVATION



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VIEW POINT


L-3

REVISIONS # description date


scale:	NOT TO SCALE
job no.:	00110066.04
drawn by:	ML
checked by:	JZ

sheet no.: L-3

sheet <u>37</u> of <u>45</u> date: 05/02/12

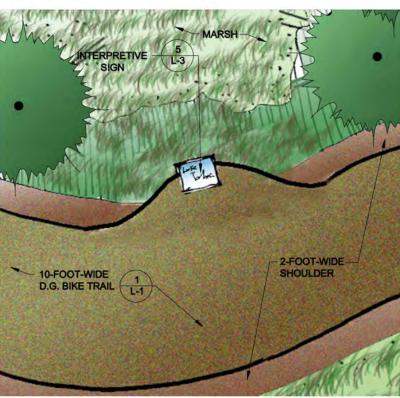

VIEW POINT (MOD.)

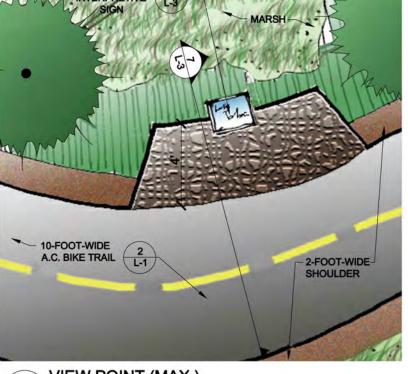

VIEW POINT (MAX.) L-3 SCALE: NTS

INTERPRETIVE 5 8' OR 10' D.G. BIKE TRAIL 2-FOOT-WIDE SHOULDER

VIEW POINT (MIN./MOD.) L-3 | SCALE: NTS **ELEVATION**




L-3 SCALE: NTS

2-FOOT-WIDE SHOULDER

PLAN VIEW

VIEW POINT (MIN./MOD.) L-3 | SCALE: NTS REPRESENTATIVE **EXAMPLE**

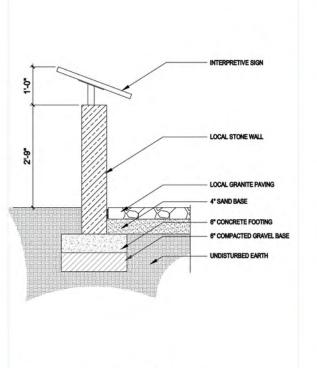


PLAN VIEW


VIEW POINT (MAX.) L-3 | SCALE: NTS SECTION L-3 | SCALE: NTS

4-FOOT-WIDE VIEW POINT 10-FOOT-WIDE A.C. BIKE TRAIL TURN-OUT 2-FOOT-WIDE -SHOULDER INTERPRETIVE

VIEW POINT (MAX.)

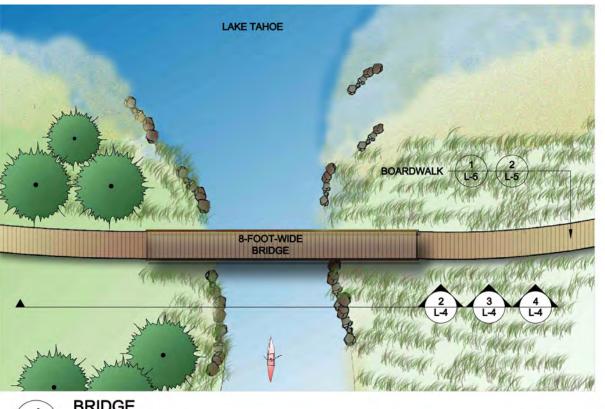

BRIDGE
L-4 SCALE: NTS PLAN VIEW

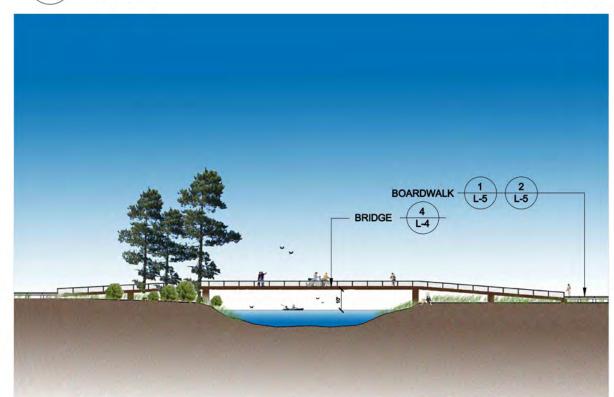

BRIDGE
L-4 SCALE: NTS ELEVATION



BRIDGE
L-4 SCALE: NTS



4 BRIDGE
L-4 SCALE: NTS

UPPER TRUCKEE RIVER

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BRIDGE

L-4

REVISIONS
description date

ELEVATION

REPRESENTATIVE EXAMPLE

| scale: NOT TO SCALE | job no.: 00110066.04 | drawn by: ML | checked by: JZ

sheet no.: L-4

sheet 38 of 45 date: 05/02/12

ADJACENT

BIKE TRAIL-

NOTES:

BOARDWALK -

MIN. = MINIMUM RECREATION INFRASTRUCTURE

MOD. = MODERATE RECREATION INFRASTRUCTURE

PLAN VIEW

MAX. = MAXIMUM RECREATION INFRASTRUCTURE



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BOARDWALK


L-5

# 4	4-4-
# description	date

NOT TO SCALE scale: 00110066.04 job no.: drawn by: ML checked by:

sheet no.: L-5

sheet <u>39</u> of <u>45</u> date: 05/02/12

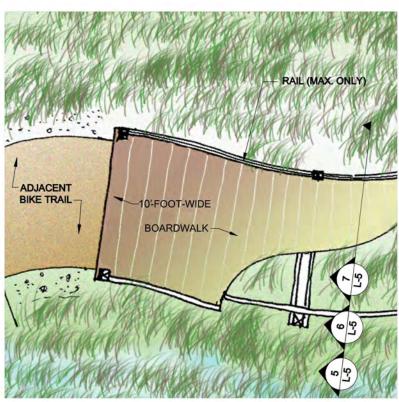

BOARDWALK (MOD./MAX.) L-5 SCALE: NTS **PLAN VIEW**



BOARDWALK (MIN.)

L-5 SCALE: NTS

8-FOOT-WIDE


BOARDWALK-

BOARDWALK (MIN.) L-5 SCALE: NTS REPRESENTATIVE **EXAMPLE**




PLAN VIEW

BOARDWALK (MOD.) L-5 | SCALE: NTS REPRESENTATIVE **EXAMPLE**

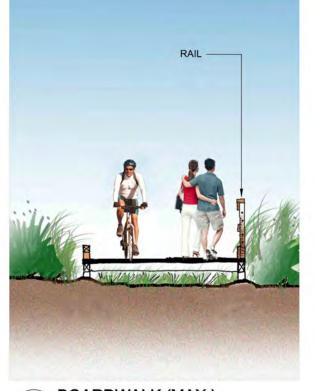

BOARDWALK (MAX.) L-5 | SCALE: NTS **ELEVATION**

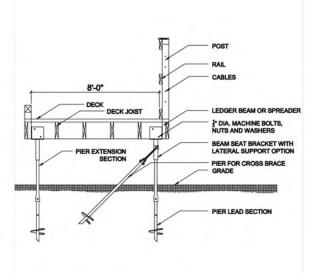

L-5 SCALE: NTS

BOARDWALK (MAX.) SECTION - D.G. BIKE TRAIL-

NOTES:

MIN. = MINIMUM RECREATION INFRASTRUCTURE

MOD. = MODERATE RECREATION INFRASTRUCTURE

MAX. = MAXIMUM RECREATION INFRASTRUCTURE

BIKE TRAIL

2-FOOT-WIDE

SHOULDER

ELEVATION



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OBSERVATION AREA TYPE 1


L-6

REVISIONS # description date

NOT TO SCALE scale: 00110066.04 job no.: drawn by: ML checked by

sheet no.: L-6

sheet __40_ of __45_ date: 05/02/12

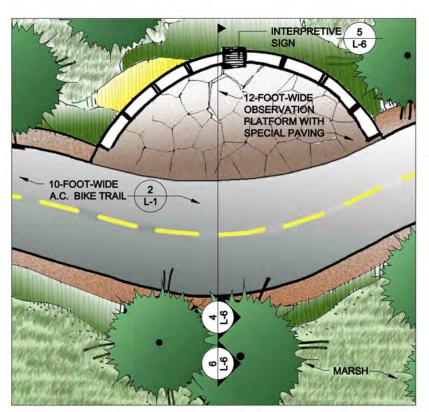

OBSERVATION AREA (MAX.) 2 SCALE: NTS **PLAN VIEW**



12-FOOT-WIDE
OBSERVATION PLATFORM

OBSERVATION AREA (MIN.)

INTERPRETIVE 5

SCALE: NTS

3

SIGN L-3

OBSERVATION AREA

L-6 INTERPRETIVE SIGN 1" CHAMFER 4" THICK CAST CONCRETE CAP 8"x8"x8" CONCRETE MASONRY UNITS RIVER COBBLE STONE VENEER # 4 REBAR (2 NO.S) ON ALTERNATE CORNERS OF CONCRETE BLOCKS 6" CONCRETE FOOTING SPECIAL PAVING COMPACTED SUBGRADE UNDISTURBED EARTH 1'-9"

OBSERVATION AREA (MAX.) 5 L-6

SCALE: NTS

L-6 | SCALE: NTS

BIKE TRAIL

OBSERVATION AREA (MAX.) L-6 SCALE: NTS

REPRESENTATIVE EXAMPLE

OBSERVATION AREA (MIN./MOD.) L-6 SCALE: NTS

12-FOOT-WIDE OBSERVATION PLATFORM INTERPRETIVE 5 6 L-6 L-6

ELEVATION

PLAN VIEW

2-FOOT-WIDE SHOULDER

INTERPRETIVE 5

SIGN

12-FOOT-WIDE **OBSERVATION PLATFORM**

SEATING BENCHES

(IN MOD. ONLY)-

SECTION

NOTES:

MIN. = MINIMUM RECREATION INFRASTRUCTURE

MOD. = MODERATE RECREATION INFRASTRUCTURE

MAX. = MAXIMUM RECREATION INFRASTRUCTURE

PLAN VIEW



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OBSERVATION AREA TYPE 2


L-7

REVISIONS # description

NOT TO SCALE scale: job no.: 00110066.04 drawn by: ML checked by:

sheet no.: L-7

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OBSERVATION AREA (MOD./MAX.) 2

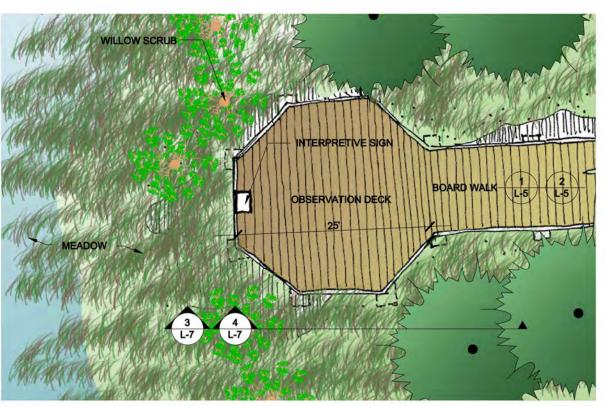SCALE: NTS

L-7

L-7 SCALE: NTS

OBSERVATION AREA SCALE: NTS **ELEVATION**

OBSERVATION AREA

REPRESENTATIVE EXAMPLE

3 L-7



BSERVATION DEC

INTERPRETIVE SIGN

NOTES:

MIN. = MINIMUM RECREATION INFRASTRUCTURE

MOD. = MODERATE RECREATION INFRASTRUCTURE

MAX. = MAXIMUM RECREATION INFRASTRUCTURE

BIKE TRAIL

1 2 L-1



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FISHING PLATFORM

L-8

REVISIONS

description

NOT TO SCALE scale: job no.: 00110066.04 drawn by: ML checked by:

sheet no.: L-8

sheet 42 of 45 date: 05/02/12

BIKE TRAIL ISHING PLATFORM

FISHING PLATFORM (MOD.) 2 L-8 SCALE: NTS

FISHING PLATFORM (MAX.) 3 L-8 SCALE: NTS



BIKE TRAIL

PLAN VIEW

L-1)

FISHING PLATFORM (MIN./MOD./MAX.) SCALE: NTS

FISHING PLATFORM SCALE: NTS L-8

REPRESENTATIVE EXAMPLE


FISHING PLATFORM (MIN.)

SCALE: NTS

L-8

L-8

ELEVATION

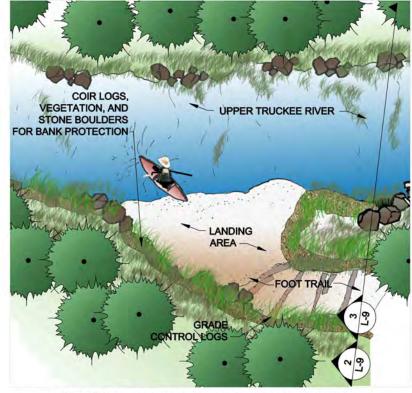

1 EXISTING RIVER ACCESS STABILIZATION
L-9 SCALE: NTS PLAN VIEW

BANK PROTECTION

GRADE
CONTROL LOGS

LANDING

RIVER

EXISTING RIVER ACCESS STABILIZATION

L-9 SCALE: NTS ELEVATION



3 EXISTING RIVER ACCESS STABILIZATION
L-9 SCALE: NTS REPRESENTATIVE EXAMPLE

DGS

UPPER TRUCKEE RIVER AND MARSH RESTORATION PROJECT

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EXISTING RIVER
ACCESS
STABILIZATION

L-9

description date

| scale: NOT TO SCALE | job no.: 00110066.04 | drawn by: ML | checked by: JZ

sheet no.: L-9

sheet 43 of 45 date: 05/02/12

8' OR 10'

D.G. BIKE TRAIL 1

NOTES:

MIN. = MINIMUM RECREATION INFRASTRUCTURE

MOD. = MODERATE RECREATION INFRASTRUCTURE

MAX. = MAXIMUM RECREATION INFRASTRUCTURE

PROTECTION FENCING

KIOSK 6

PLAN VIEW

SPECIAL PAVING



UPPER TRUCKEE RIVER AND MARSH RESTORATION **PROJECT**

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KIOSK

L-10

date


REVISIONS # description

NOT TO SCALE scale: 00110066.04 job no.: drawn by: ML


sheet no.: L-10

checked by:

sheet <u>44</u> of <u>45</u> date: 05/02/12

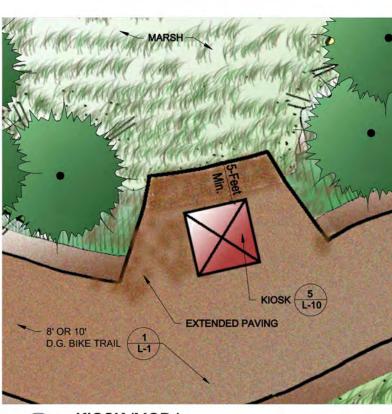


KIOSK (MOD.) 2 L-10 SCALE: NTS

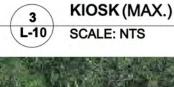

10-FOOT-WIDE A.C. BIKE TRAIL 2 L-1




KIOSK (MAX.) L-10 SCALE: NTS REPRESENTATIVE EXAMPLE

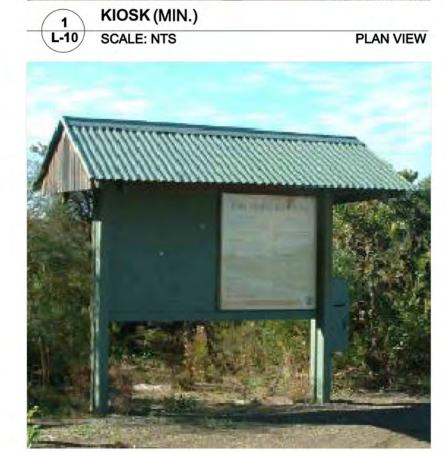

KIOSK 4


KIOSK (MIN.) L-10 SCALE: NTS REPRESENTATIVE EXAMPLE

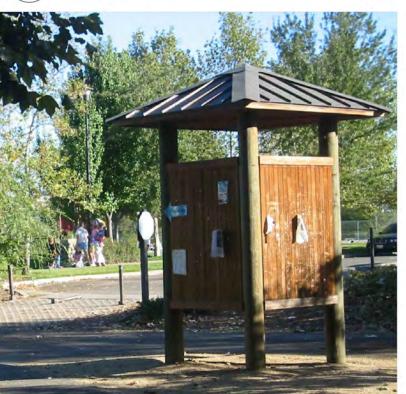

KIOSK (MOD.) 5 L-10 SCALE: NTS

PLAN VIEW

REPRESENTATIVE EXAMPLE

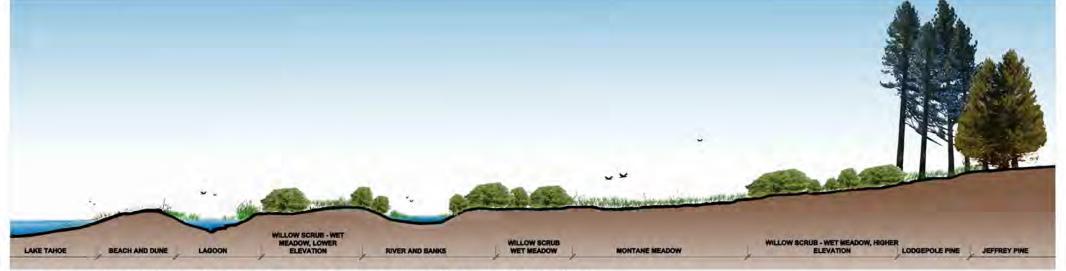

1 REVEGETATION AND HABITAT RELATIONSHIPS
SECTION

PLANT LIST

Scientific Name	Common Name	Growth	Beach and	Lagoon	Willow Scrub-Wet Meadow, Lower Elevation	Riverbanks	Willow Scrub-Wet Meadow, Higher Elevation	Montane Meadow	Lodgepole Pine	Jeffrey Pine
Scirpus acutus	Tule	P		X		, attitude and	ale radell	in a data	1	1 410
Sparganium emersum ssp. emersum	Emersed bur-reed	P		X		-				
Typha angustifolium	Cattail	P		X						
Achnetherum occidentalis	Western needlegrass	G		- ~					X	X
Agrostis exarata	Spike bentgrass	G				X			- ^-	
Alopecurus aequalis	Short-awn foxtail	G		X	X					
Bromus carinatus	California brome	G		- 1	-					X
Carex aquatilis	Water Sedge	G	x	X	X		X			
Carex athrostachya	Blister sedge	G		_^_		1	X	X		
Carex nebraskensis	Nebraska sedge	G	X		X	X	X	X	X	X
Carex utriculata	Beaked sedge	G	- ^	X	X	1	X	X		
Deschampsia cespitosa var. cespitosa	Tufted hairgrass	G					x	x		
Deschampsia danthonoides	Annual hairgrass	G	X					- "		
Eleocharis macrostachya	Common spikerush	G		X	X	X				
Elymus glaucus	Blue wildrye	G		^	_^	^	X	1	X	_
Elymus trachycaulus var. intermedia	Intermediate Wheatgrass	G			1	1	_^	X	- ^	1
Festuca rubra	Red fescue	G			1	-		X		-
Glyceria elata	Fowl mannagrass	G		х	X	X		-		-
Hordeum brachyantherum	Meadow barley	G	X	_^_	- ^-			x		-
Hordeum jubatum	Foxtail barley	G	X					- "		
Juncus balticus	Wiregrass, Baltic rush	G	X	х	X	X	X			
Juncus effusus	Common rush	G	-	X	X	X	X			-
Juncus ensifolius	Sword-leaved rush	G		^	_ A	X	X			
luncus nevadensis	Nevada rush	G	X			^	_ ^	X		
Juncus orthophyllus	Straight-leaved rush	G	_^		_			X	1	1
Leymus triticoides	Creeping wildrye	G	X		1	1		- A	X	X
Poa secunda var. nevadensis	Bluegrass	G	^					X	X	X
Scirpus micropus	Small Fruited Bulrush	G				X		_^		- ^
Achillea millefolium	Yarrow	P	X			^		X	x	X
Amica chamossonis var. foliosa	Amica	P	x					X	X	_^
Aster occidentalis	Western mountain aster	P	x					x	x	X
Fragaria virginiana	Mountain strawberry	P	X					X	X	^
Linum lewisii	Flax	P	-			1		x	, A	
Lupinus breweri	Brewer's lupine	P				illi		_^		X
Lupinus lepidus var. confertus	Clustered tidy lupine	P	X					1		X
Lupinus polyphyllus	Big lupine	P	_^				X	X	X	^
Denothera elata var. hookeri	Evening primrose	P	X					^	^	1

PLANT LIST CONTINUED

Scientific Name	Common Name	Growth Form	Beach and	Lagoon	Willow Scrub-Wet Meadow, Lower Elevation	Riverbanks	Willow Scrub-Wet Meadow, Higher Elevation	Montane Meadow	Lodgepole Pine	Jeffrey Pine
Penstemon rydbergii var. oreocharis	Meadow beardtongue	Р						X	X	X
Phacelia hastata	Silverleaf phacelia	P								X
Polygonum bistortoides	Western bisort	P					X	X		
Potentilla glandulosa	Cinquefoil	P					X	X	X	
Potentilla gracilis	Cinquefoil	P	X				X	X	X	
Sidalcea oregana ssp. spicata	Checker mallow	P				X	X	X	X	
Smilacina stellata	False Solomon's seal	P							Х	
Stachys ajugoides var. rigida	Hedge nettle	P					X		X	X
Trifolium longipes	Long-stalked clover	P					X	X	X	
Nuphar luteum var. polysepalum	Yellow pond-lily	Р		X						
Polygonum amphibium	Water smartweed	P		X	X					
Polygonum hydropiperoides	Waterpepper	P		X	X					
Rumex salicifolius	Willow-leaved dock	Р		X	Х	X				
Amelanchier alnifolia	Serviceberry	S							X	
Arctostaphylos patula	Greenleaf Manzanita	S								X
Artemisia tridentata var. vaseyana	Mountain sagebrush	S							X	X
Berberis aquifolium var. repens	Oregon grape	S								X
Ceanothus prostratus	Squaw carpet	S								X
Chrysothamnus nauseosus	Rubber rabbitbrush	S								X
Lonicera conjugalis	Double honeysuckle	S								X
Ribes cereum	Wax currant	S								X
Ribes lacustre	Swamp currant	S					X		X	X
Ribes roezlii var. roezlii	Sierra currant	S								X
Rosa woodsii var. ultramontana	Interior rose	S							X	X
Salix exigua	Narrow-leaved willow	S	Х			X				
Pinus contorta var. murrayana	Lodgepole pine	T							X	X
Pinus jeffreyi	Jeffrey pine	T								X
Salix geyeriana	Geyer's willow	T		X	X					
Salix lemmonii	Lemmon's willow	T	X	X	X	X	X		X	
Salix lucida var. lasiandra	Shining willow	T		X	X	X				
Salix scouleriana	Scouler's willow	T		11			х		X	
Total Number of Species			17.0	15.0	14.0	13.0	19.0	22.0	24.0	24.0

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G-GRASS P-PERENNIAL S-SHRUB T-TREE



UPPER TRUCKEE RIVER AND MARSH RESTORATION PROJECT

E.I.P. # 560



870 Emerald Bay Road, Suite 400 South Lake Tahoe, CA 96150 Tel: 530.543.5100 Fax: 530.543.5150



1048 Ski Run Blvd. South Lake Tahoe, CA 96150 Tel: 530.542.0201 Fax: 530.542.4401

REVEGETATION SECTION AND

PLANT LIST

L-11

REVISIONS
description date

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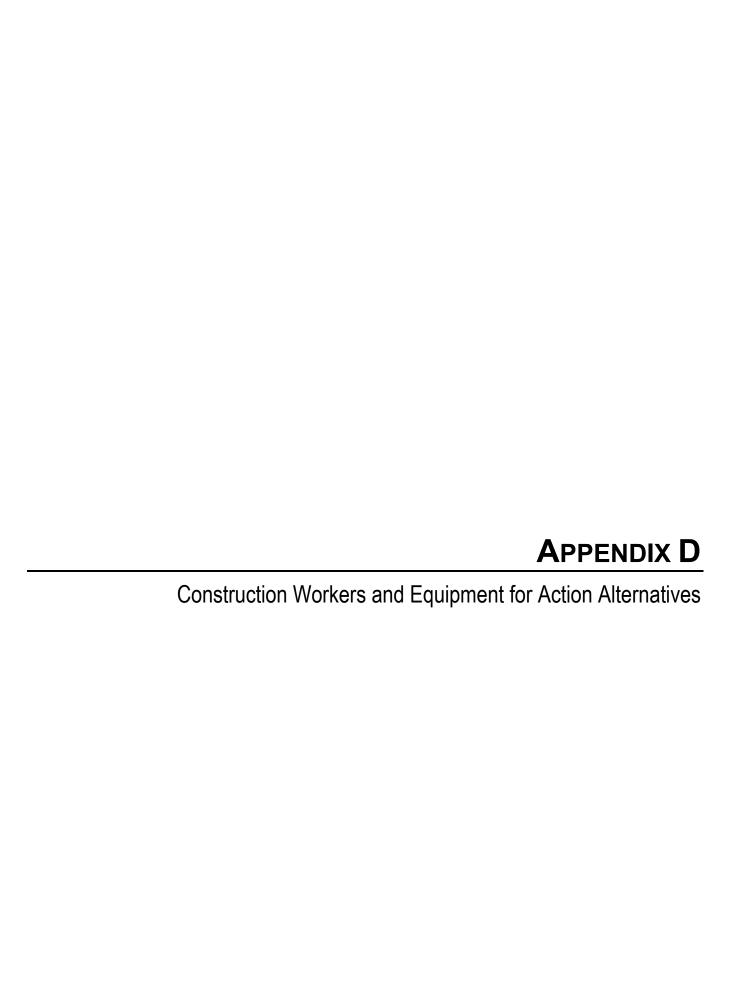
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 drawn by:
 ML

 checked by:
 JZ

sheet no.: L-11

sheet 45 of 45 date: 05/02/12



Activities/Engineered Feature	Construction Activities/Engineered Feature (#)			ers	Construction Equipment					
Ü		Alt. 2	Alt. 3	Alt. 4						
Year 1										
Mobilization (Alt. 1–4)	5	5	5	5	20 ton Dump Truck (Multiple); Cat 120H Motor Grader; Cat D6 Dozer; Cat D9 Dozer; Cat TL642 Forklift; Cat 420E Backhoe Loader; Water Truck; 1 Ton Pickup Truck (2)					
Re-contoured Existing Channel (Alt. 1, 3)	6	-	6	-	20 ton Dump Truck; Cat D6 Dozer; Cat D9 Dozer; Cat 330 Excavator; Cat 420E Backhoe Loader; Cat TL642 Forklift; Rain for Rent DV-300 5000 GPM Electric Pump (2); Aquadam Water-Filled Berm; 12" and 10" Dewatering hose/pipe; Water Truck; 1 Ton Pickup Truck (2)					
Lowered Floodplain (Alt. 1–4)	5	5	6	6	Alt. 1–3: 20 ton Dump Truck; Cat D6 Dozer; Cat D9 Dozer; Cat 330 Excavator (2); Cat 420E Backhoe Loader; Water Truck; 1 Ton Pickup Truck (2) Alt. 4: same as Alt. 1–3, except 20 ton Dump Truck(3)					
Inset Floodplain (Alt. 4)	-	-	-	8	20 ton Dump Truck(6); Cat D6 Dozer; Cat D9 Dozer(2); Cat 330 Excavator (2); Cat 420E Backhoe Loader; Aquadam Water-Filled Berm; Water Truck; 1 Ton Pickup Truck (2)					
Existing Secondary Channel (Alt. 1–4)	3	3	3	3	Alt. 1 and 2: 21 ton Dump Truck; Cat D6 Dozer; Cat D9 Dozer; Cat 330 Excavator (2); Cat 420E Backhoe Loader; Water Truck; 1 Ton Pickup Truck (2) Alt. 3 and 4: 20 ton Dump Truck; Cat D6 Dozer; Cat D9 Dozer; Cat 330 Excavator; Cat 420E Backhoe Loader; Cat TL642 Forklift; Rain for Rent DV-300 5000 GPM Electric Pump (2); Aquadam Water-Filled Berm; 12" and 10" Dewatering hose/pipe; Water Truck; 1 Ton Pickup Truck (2)					
New Channel (Alt. 1)	10	-	_	-	20 ton Dump Truck (Multiple); Cat D6 Dozer; Cat D9 Dozer; Cat 330 Excavator (3); Cat 420E Backhoe Loader; Cat TL642 Forklift; Rain for Rent DV-300 5000 GPM Electric Pump (2); Aquadam Water-Filled Berm; 12" and 10" Dewatering hose/pipe; Water Truck; 1 Ton Pickup Truck (2)					
New Channel and River Mouth Modification (Alt. 2)	-	10	-	-	20 ton Dump Truck (Multiple); Cat D6 Dozer; Cat D9 Dozer; Cat 330 Excavator (3); Cat 420E Backhoe Loader; Cat TL642 Forklift; Rain for Rent DV-300 5000 GPM Electric Pump (2); Aquadam Water-Filled Berm; 12" and 10" Devetoring hass trips. Water Trucks 1. Ton Picker Truck (2)					

10" Dewatering hose/pipe; Water Truck; 1 Ton Pickup Truck (2)

Appendix '
Construction Workers and Equipment for Action Alternatives

Cons	truction	n Worke		ppend Lequip	ix ' oment for Action Alternatives
Activities/Engineered Feature		nstructio (#		ers	Construction Equipment
	Alt. 1	Alt. 2	Alt. 3	Alt. 4	
New Channel and Vertical and Lateral Grade Controls (Alt. 3)	-	-	10	-	20 ton Dump Truck (Multiple); Cat D6 Dozer (2); Cat D9 Dozer (2); Cat 330 Excavator (3); Cat 420E Backhoe Loader; Cat TL642 Forklift; Rain for Rent DV-300 5000 GPM Electric Pump (2); Aquadam Water-Filled Berm; 12" and 10" Dewatering hose/pipe; Water Truck; 1 Ton Pickup Truck (2)
Revegetation/Irrigation (Alt. 1–4)	8	8	4	8	Cat D6 Dozer w/scarifier; Cat D9 Dozer; Cat 330 Excavator; Cat 420E Backhoe Loader; Cat TL642 Forklift; Truck Mounted Hydroseeder; Trailer Mounted Straw Mulcher; Bobcat Trencher; Water Truck; 1 Ton Pickup Truck (2)
Winterization (Alt. 1–4)	4	4	4	4	20 ton Dump Truck (Multiple); Cat D6 Dozer; Cat D9 Dozer; Cat TL642 Forklift; Cat 420E Backhoe Loader; Water Truck; 1 Ton Pickup Truck (2)
				Year	2
Mobilization (Alt. 1–4)	4	4	4	4	20 ton Dump Truck (Multiple); Cat 120H Motor Grader; Cat D6 Dozer; Cat D9 Dozer; Cat TL642 Forklift; Cat 420E Backhoe Loader; Water Truck; 1 Ton Pickup Truck (2)
New Channel and Lowered Floodplain (Alt. 1)	3	-	-	-	Cat TL642 Forklift; Cat 420E Backhoe Loader; Water Truck; 1 Ton Pickup Truck (2)
New Channel, River Mouth Modification, and Lowered Floodplain (Alt. 2)	-	3	-	1	Cat TL642 Forklift; Cat 420E Backhoe Loader; Water Truck; 1 Ton Pickup Truck (2)
New Channel, Recontoured Existing Channel, Existing Secondary Channel, and Lowered Floodplain (Alt. 3)	-	-	3	1	Cat TL642 Forklift; Cat 420E Backhoe Loader; Water Truck; 1 Ton Pickup Truck (2)
Existing Secondary Channel, Inset Floodplain and Lowered Floodplain (Alt. 4)	-	-	-	4	Cat TL642 Forklift; Cat 420E Backhoe Loader; Water Truck; 1 Ton Pickup Truck (2)
Bank Protection (Alt. 1–4)	7	7	7	7	20 ton Dump Truck; Cat D6 Dozer; Cat 330 Excavator (2); Cat 420E Backhoe Loader; Cat TL642 Forklift; Rain for Rent DV-300 5000 GPM Electric Pump (2); Aquadam Water-Filled Berm; 12" and 10" Dewatering hose/pipe; Water Truck; 1 Ton Pickup Truck (2)
Overflow culverts (Alt. 3)	-	-	5	-	Cat D6 Dozer; Cat 420E Backhoe Loader; Cat TL642 Forklift; Jack and Bore Drill Rig; Water Truck; 1 Ton Pickup Truck (2)

Appendix ' Construction Workers and Equipment for Action Alternatives							
Activities/Engineered Feature			on Work †)	ers	Construction Equipment		
-	Alt. 1	Alt. 2	Alt. 3	Alt. 4			
Vertical Grade Controls (Alt. 1)	6	-	-	ı	20 ton Dump Truck; Cat D6 Dozer; Cat D9 Dozer; Cat 330 Excavator; Cat 420E Backhoe Loader; Cat TL642 Forklift; Rain for Rent DV-300 5000 GPM Electric Pump (2); Aquadam Water-Filled Berm; 12" and 10" Dewatering hose/pipe; Water Truck; 1 Ton Pickup Truck (2)		
Vertical grade controls and River Mouth Modification (Alt. 3)	-	-	6	-	20 ton Dump Truck; Cat D6 Dozer; Cat D9 Dozer; Cat 330 Excavator; Cat 420E Backhoe Loader; Cat TL642 Forklift; Rain for Rent DV-300 5000 GPM Electric Pump (2); Aquadam Water-Filled Berm; 12" and 10" Dewatering hose/pipe; Water Truck; 1 Ton Pickup Truck (2)		
Restored Floodplain (Alt. 4)	-	-	-	6	20 ton Dump Truck (Multiple); Cat D6 Dozer (3); Cat D9 Dozer (3); Cat 330 Excavator (3); Cat 420E Backhoe Loader; Cat TL642 Forklift; Aquadam Water-Filled Berm; Water Truck; 1 Ton Pickup Truck (2)		
Recontoured Existing Channel (Alt. 4)	-	-	-	8	20 ton Dump Truck; Cat D6 Dozer; Cat D9 Dozer; Cat 330 Excavator; Cat 420E Backhoe Loader; Cat TL642 Forklift; Rain for Rent DV-300 5000 GPM Electric Pump (2); Aquadam Water-Filled Berm; 12" and 10" Dewatering hose/pipe; Water Truck; 1 Ton Pickup Truck (2)		
Bulkhead and Levee (Alt. 1–3)	5	5	5	1	Barge Mounted Pile Driver; 20 ton Dump Truck (multiple); Cat D6 Dozer (2); Cat D9 Dozer; Cat 330 Excavator (2); Cat 825 Compactor; Cat 420E Backhoe Loader; Cat TL642 Forklift; Rain for Rent DV-300 5000 GPM Electric Pump (3); Aquadam Water-Filled Berm; 12" and 10" Dewatering hose/pipe; Water Truck; 1 Ton Pickup Truck (2)		
Restored Lagoon (Alt. 1–3)	4	4	4	-	Cat D6 Dozer w/scarifier; Cat D9 Dozer; Cat 330 Excavator; Cat 420E Backhoe Loader; Cat TL642 Forklift; Rain for Rent DV-300 5000 GPM Electric Pump (2); Aquadam Water-Filled Berm; 12" and 10" Dewatering hose/pipe; Truck Mounted Hydroseeder; Trailer Mounted Straw Mulcher; Water Truck; 1 Ton Pickup Truck (2)		
Revegetation/Irrigation (Alt. 1–4)	8	8	8	8	Cat D6 Dozer w/scarifier; Cat D9 Dozer; Cat 330 Excavator; Cat 420E Backhoe Loader; Cat TL642 Forklift; Truck Mounted Hydroseeder; Trailer Mounted Straw Mulcher; Bobcat Trencher; Water Truck; 1 Ton Pickup Truck (2)		
Winterization (Alt. 1–4)	4	4	4	4	20 ton Dump Truck (Multiple); Cat D6 Dozer; Cat D9 Dozer; Cat TL642 Forklift; Cat 420E Backhoe Loader; Water Truck; 1 Ton Pickup Truck (2)		


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Appendix ' Construction Workers and Equipment for Action Alternatives										
Activities/Engineered Feature	Co	nstructio (#		ers	Construction Equipment					
· ·	Alt. 1	Alt. 2	Alt. 3	Alt. 4						
Year 3										
Mobilization (Alt. 1–4)	4	4	4	4	20 ton Dump Truck (Multiple); Cat 120H Motor Grader; Cat D6 Dozer; Cat D9 Dozer; Cat TL642 Forklift; Cat 420E Backhoe Loader; Water Truck; 1 Ton Pickup Truck (2)					
New Channel, Re-contoured Existing Channel, and Lowered Floodplain (Alt. 1)	4	-	-	-	Cat TL642 Forklift; Cat 420E Backhoe Loader; Water Truck; 1 Ton Pickup Truck (2)					
New Channel, River Mouth Modification, and Lowered Floodplain (Alt. 2)	-	4	-	-	Cat TL642 Forklift; Cat 420E Backhoe Loader; Water Truck; 1 Ton Pickup Truck (2)					
Re-contoured Existing Channel, Existing Secondary Channel, and Lowered Floodplain (Alt. 3)	-	-	4	-	Cat TL642 Forklift; Cat 420E Backhoe Loader; Water Truck; 1 Ton Pickup Truck (2)					
Existing Secondary Channel, Inset Floodplain, Lowered Floodplain, and Re-contoured Existing Channel (Alt. 4)	-	-	-	4	Cat TL642 Forklift; Cat 420E Backhoe Loader; Water Truck; 1 Ton Pickup Truck (2)					
Excavation of Reserve Fill at Lower West Side and fill at TKPOA yard (Alt. 1, 2, and 3)	6	6	6	-	20 ton Dump Truck (Multiple); Cat D6 Dozer (3); Cat D9 Dozer (3); Cat 330 Excavator (3); Cat 420E Backhoe Loader; Cat TL642 Forklift; Aquadam Water-Filled Berm; Water Truck; 1 Ton Pickup Truck (2)					
Public Access and Habitat Protection Features (Alt. 1, 2, and 4)	15	15	15	15	20 ton Dump Truck; Cat D6 Dozer (2); Cat D9 Dozer(2); Cat 330 Excavator (3); Cat 120H Motor Grader; Cat 825 Compactor; Cat BG-225 Asphalt Paver; Cat 420E Backhoe Loader; Cat TL642 Forklift; Water Truck; 1 Ton Pickup Truck (2)					
Restored Lagoon (Alt. 1 and 2)	4	4	-	-	20 ton Dump Truck; Cat D6 Dozer; Cat D9 Dozer; Cat 330 Excavator; Cat 420E Backhoe Loader; Cat TL642 Forklift; Rain for Rent DV-300 5000 GPM Electric Pump (2); 12" and 10" Dewatering hose/pipe; Truck Mounted Hydroseeder; Trailer Mounted Straw Mulcher; Water Truck; 1 Ton Pickup Truck (2)					
River Mouth Modification (Alt. 1)	5	-	-	-	20 ton Dump Truck; Cat D6 Dozer; Cat D9 Dozer; Cat 330 Excavator; Cat 420E Backhoe Loader; Cat TL642 Forklift; Rain for Rent DV-300 5000 GPM Electric Pump (2); Aquadam Water-Filled Berm; 12" and 10" Dewatering hose/pipe; Water Truck; 1 Ton Pickup Truck (2)					

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Appendix D Construction Workers and Equipment for Action Alternatives								
Activities/Engineered Feature		nstructio (#		ers	Construction Equipment			
		Alt. 1 Alt. 2 Alt. 3 Alt. 4		Alt. 4				
Restored Dunes (Alt. 1 and 2)	3	3	-	-	20 ton Dump Truck; Cat D6 Dozer; Cat D9 Dozer; Cat 330 Excavator; Cat 420E Backhoe Loader; Truck Mounted Hydroseeder; Trailer Mounted Straw Mulcher; Water Truck; 1 Ton Pickup Truck (2)			
New Channel and Re-contoured Existing Channel (Alt. 1)	8	-	-	-	Cat D6 Dozer; Cat D9 Dozer; Cat 330 Excavator (2); Cat 420E Backhoe Loader; Cat TL642 Forklift; Rain for Rent DV-300 5000 GPM Electric Pump (3); Aquadam Water-Filled Berm; 12" and 10" Dewatering hose/pipe; Water Truck; 1 Ton Pickup Truck (2)			
New Channel and River Mouth Modification (Alt. 2)	-	10	1	-	Cat D6 Dozer; Cat D9 Dozer; Cat 330 Excavator (2); Cat 420E Backhoe Loader; Cat TL642 Forklift; Rain for Rent DV-300 5000 GPM Electric F (3); Aquadam Water-Filled Berm; 12" and 10" Dewatering hose/pipe; W Truck; 1 Ton Pickup Truck (2)			
Vertical and Lateral Grade Controls (Alt. 1, 2, and 3)	6	6	6	-	20 ton Dump Truck; Cat D6 Dozer; Cat D9 Dozer; Cat 330 Excavator; Cat 420E Backhoe Loader; Cat TL642 Forklift; Rain for Rent DV-300 5000 GPM Electric Pump (2); Aquadam Water-Filled Berm; 12" and 10" Dewatering hose/pipe; Water Truck; 1 Ton Pickup Truck (2)			
Partial Backfill and Complete Backfill Old Channel (Alt. 1, 2, and 3)	8	8	8	-	20 ton Dump Truck (Multiple); Cat D6 Dozer (2); Cat D9 Dozer (2); Cat 330 Excavator (2); Cat 420E Backhoe Loader; Cat TL642 Forklift; Cat 825 Compactor; Truck Mounted Hydroseeder; Trailer Mounted Straw Mulcher; Rain for Rent DV-300 5000 GPM Electric Pump (3); Aquadam Water-Filled Berm; 12" and 10" Dewatering hose/pipe; Water Truck; 1 Ton Pickup Truck (2)			
Restored Lagoon (Alt. 1, 2, and 3)	3	3	3	-	20 ton Dump Truck; Cat D6 Dozer; Cat D9 Dozer; Cat 330 Excavator; Cat 420E Backhoe Loader; Cat TL642 Forklift; Rain for Rent DV-300 5000 GPM Electric Pump (2); Aquadam Water-Filled Berm; 12" and 10" Dewatering hose/pipe; Water Truck; 1 Ton Pickup Truck (2)			
Restored Floodplain (Alt. 1, 2, and 3)	6	6	6	-	20 ton Dump Truck; Cat D6 Dozer; Cat D9 Dozer; Cat 330 Excavator; Cat 420E Backhoe Loader; Cat TL642 Forklift; Truck Mounted Hydroseeder; Trailer Mounted Straw Mulcher; Water Truck; 1 Ton Pickup Truck (2)			
Stormwater Treatment Basins (Alt. 2 and 3)	-	4	4	-	20 ton Dump Truck; Cat D6 Dozer; Cat D9 Dozer; Cat 330 Excavator; Cat 420E Backhoe Loader; Water Truck; 1 Ton Pickup Truck (2)			

Appendix D Construction Workers and Equipment for Action Alternatives									
Activities/Engineered Feature	Construction Workers (#)				Construction Equipment				
	Alt. 1	Alt. 2	Alt. 3	Alt. 4					
Revegetation/Irrigation (Alt. 1–4)	8	8	8	8	Cat D6 Dozer w/scarifier; Cat D9 Dozer; Cat 330 Excavator; Cat 420E Backhoe Loader; Cat TL642 Forklift; Truck Mounted Hydroseeder; Trailer Mounted Straw Mulcher; Bobcat Trencher; Water Truck; 1 Ton Pickup Truck (2)				
Winterization (Alt. 1–4)	4	4	4	4	20 ton Dump Truck (Multiple); Cat D6 Dozer; Cat D9 Dozer; Cat TL642 Forklift; Cat 420E Backhoe Loader; Water Truck; 1 Ton Pickup Truck (2)				
Year 4									
Mobilization (Alt. 1–4)	4	4	4	4	20 ton Dump Truck (Multiple); Cat 120H Motor Grader; Cat D6 Dozer; Cat D9 Dozer; Cat TL642 Forklift; Cat 420E Backhoe Loader; Water Truck; 1 Ton Pickup Truck (2)				
Revegetation/Irrigation (Alt. 1–4)	4	4	4	4	Cat TL642 Forklift; Cat 420E Backhoe Loader; Bobcat Trencher; Water Truck; 1 Ton Pickup Truck (2)				
Winterization and Project Shutdown (Alt. 1–4)	4	4	4	4	20 ton Dump Truck (Multiple); Cat D6 Dozer; Cat D9 Dozer; Cat TL642 Forklift; Cat 420E Backhoe Loader; Truck Mounted Hydroseeder; Trailer Mounted Straw Mulcher; Water Truck; 1 Ton Pickup Truck (2)				



INITIAL COST ANALYSIS

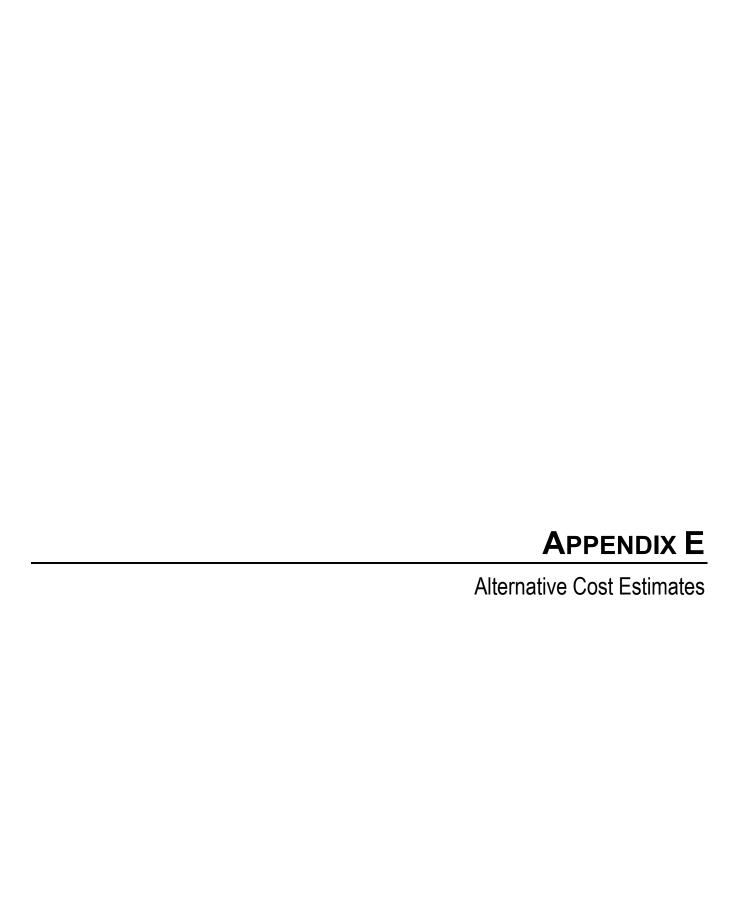In 2006, estimated costs for each Alternative were developed using standard cost estimating practices for civil engineering and environmental restoration projects. This information was created for the Concept Plan Report prepared for the project in 2006 and represents the alternatives at this stage in some instances features have been added or deleted and therefore do not represent the most current alternatives. The purpose of this section was simply to provide a relative representation of the costs of the various alternatives. A summary of the results are presented in the following table. Table 1 provides estimated costs based on estimated quantities and information available at that time. They were developed for planning purposes only and based on best available information.

In order to evaluate the four alternatives, general assumptions were made and applied similarly to each alternative. These included typical cross-sections of new channel, typical cross-sections of existing channel to be filled, spacing of habitat improvement features, construction access road width and length, etc. Unit costs were derived using a combination of actual costs from LWS and Trout Creek Restoration projects, cost publications like RSMeans Site Work and Landscape Cost Data, data provided by resource agencies like Washington State Department of Fish and Wildlife and Alaska Department of Fish and Wildlife, and the design teams extensive knowledge of the site and professional experience. Design and permitting costs were included as 40% of construction.

Based on total cost, Alternative 3 is least expensive, followed by Alternative 2, 1, and 4. Total costs range from \$5.9M for Alternative 3 to \$19.7M for Alternative 4. This large range is due primarily to the differences in earthwork volumes and level of recreation infrastructure. If only site work, contractor costs, design and permitting costs are considered, since the three levels of recreation infrastructure, maximum, moderate and minimum, could be easily applied to any of the 4 alternatives, the only change in the resulting ranking is that Alternative 1 and 2 are switched.

Description		Alternative 1	Alternative 2	Alternative 3	Alternative 4
Recreation/Public Access					
Trooreations abile 7 to cocc					
	Visitor Center	\$900,000	\$0	\$100,000	\$100,000
	Boardwalk	\$500,000	\$0	\$287,500	\$262,500
	Public Access Trails	\$45,000	\$13,800	\$31,050	\$23,100
	Overlook/Viewing Platform	\$67,500	\$45,000	\$60,000	\$45,000
	Signage	\$31,500	\$21,000	\$28,000	\$21,000
	Decorative Fencing	\$600,000	\$200,000	\$400,000	\$400,000
	Subtotal	\$2,144,000	\$279,800	\$906,550	\$851,600
Site Work					
	Site Preparation/ Clearing	\$5,875	\$13,750	\$6,150	\$22,335
	Access Roads/Channel Crossings	\$150,900	\$186,000	\$94,500	\$9,000
	Channel Construction	\$1,200,220	\$1,615,075	\$155,540	\$10,067,540
	Channel Backfill (off-site borrow, in-basin)	\$0	\$644,125	\$285,000	\$0
	Channel Backfill (on-site borrow)	\$325,330	\$350,000	\$350,000	\$70,000
	Bank Stabilization/Protection	\$900,000	\$900,000	\$900,000	\$900,000
	Habitat Structures (200 ft spacing)	\$32,000	\$43,000	\$10,000	\$47,000
	Lateral Grade Controls	\$12,500	\$15,000	\$2,500	\$0
	Vertical Grade Controls	\$180,000	\$60,000	\$60,000	\$0
	Irrigation System	\$255,000	\$255,000	\$255,000	\$255,000
	Revegetation/Erosion Control	\$150,000	\$150,000	\$150,000	\$150,000
	Dewatering	\$250,000	\$250,000	\$250,000	\$250,000
	Bulkhead	\$250,000	\$250,000	\$250,000	\$0
	Construction Fencing	\$80,000	\$80,000	\$80,000	\$80,000
	Subtotal	\$3,791,825	\$4,811,950	\$2,848,690	\$11,850,875
Contractor Costs					
	Mobilization/Demobilization	\$379,183	\$481,195	\$284,869	\$1,185,088
	Surveying	\$10,000	\$10,000	\$10,000	\$10,000
	Road Repair	\$100,000	\$100,000	\$100,000	\$100,000
	Staging/Laydown	\$50,000	\$50,000	\$50,000	\$50,000
	Subtotal	\$539,183	\$641,195	\$444,869	\$1,345,088
Design and Permitting					
	Design (20%)	\$1,295,002	\$1,146,589	\$840,022	\$2,809,513
	Permitting (20%)	\$1,295,002	\$1,146,589	\$840,022	\$2,809,513
	Subtotal	\$2,590,003	\$2,293,178	\$1,680,044	\$5,619,025
	Total	\$9,065,011	\$8,026,123	\$5,880,153	\$19,666,588